

300 Forest Avenue, Pacific Grove, California 93950

AGENDA REPORT

TO: Chair Boyle and Members of the Architectural Review Board

FROM: Laurel O'Halloran, Associate Planner

MEETING DATE: July 9, 2019

SUBJECT: Architectural Permit Application No. 18-1031 to allow a comprehensive

exterior remodel, allowing for a contemporary exterior.

ADDRESS: 1205 Ocean View Boulevard, Pacific Grove (APN 006-012-017)

ZONING/ R-1-H//Medium Density to 17.4 DU/ac

LAND USE:

APPLICANT: Mark Mueckenheim architect, on behalf of Stacey Tang, owner

CEQA: Categorical Exemption, Section 15301(a)(1), Existing Facilities

RECOMMENDATION

Because of the project's consistency with the Zoning Ordinance and General Plan, and minimal impact on surrounding properties, staff recommends that the Architectural Review Board:

APPROVE AP No 18-1031 pursuant to PGMC 23.70.060(a) (1) and subject to the attached findings, conditions of approval and a Section 15301(a)(1) CEQA categorical exemption for existing facilities.

PROJECT DESCRIPTION

The proposed exterior remodel creates a contemporary style by allowing the removal of the exterior siding to be replaced with vertical open joint untreated cedar cladding and removing and replacing all windows. The new windows will be extended from the floor to ceiling and the window sill parapet on the second floor will be removed. The existing bay windows will also be removed. The new façade will be flat. The angled shingle siding mansford roof will be removed and the garden wall will have new cedar siding. The front door is proposed to be replaced with a new pivoting glass door.

The new wooden siding replicates the design and construction of other wood buildings in the area and fits harmoniously into the natural setting and the surrounding urban fabric as a modern vernacular style. The natural coloring of the siding will give the house a very modest and subdued appearance over time.

BACKGROUND

On December 19, 2018, an application was received for an Architectural Permit to allow the exterior renovation of the existing two story residence located at 1205 Ocean View Boulevard.

The proposed development will meet the development regulations set forth in the R-1-H zoning district including setbacks and height requirements. The residence is in an archeological zone and in an Area of Special Biological Significance, however no ground disturbance is proposed for this permit.

SURROUNDING LAND USES

The property is located in the Pacific Grove Fairway Homes Tract across the street from the ocean. The property is relatively flat and will be served by public utilities.

DISCUSSION

Applicable General Plan Policies

The subject residence is a two-story wood framed structure that was built in 1987. The following General Plan, Archaeological Resources, Chapter 7 and Chapter 8, goals, policies, and programs are applicable to the Architectural Permit application.

Program AA Inspect the surface of sites which potentially contain archaeological resources and evaluate site records to determine the extent of the known archaeological resources.

Policy 2 Continue to require citywide architectural review for exterior changes to existing structures.

Program B While recognizing the individuality of existing neighborhoods encourage additions that contribute to the character of the area, while allowing for creativity in design.

Applicable Zoning Code Regulations

The intention of the R-H district is to preserve the characteristics of a feeling of open space around dwellings and to preserve public views of the ocean, sky and trees. The proposed project does not add any additional square footage to the existing residence. The allowable maximum building coverage is 35% and the existing residence has a building coverage of 29%. The allowable maximum site coverage is 60% and the existing residence has site coverage of 28.47%.

Architecture and Design Consideration

Diverse architectural styles lie at the heart of Pacific Grove's distinctive character. The Architectural Review Guidelines do not define contemporary or modern style. Instead the following styles are described an illustrated: Tudor, Spanish Revival, Italianate, Craftsman Bungalow, Prarie, American Foursquare, Shingle, Vernacular, Colonial Revival, and Queen Anne., the "Ranch-style" of the existing house is also not listed. However, a "mix of diverse architectural styles" including modern and "a variety of other historic and modern architectural styles" is described as distinctive for the urban and suburban fabric of Pacific Grove in the Architectural Design Guidelines. The remodel of the house is within a modern vernacular architectural style,

The project proposal adheres to the following Architectural Review Guidelines:

Guideline # 12: Choose light fixtures that are compatible with the architectural style of the project.

The project proposes light fixture which are compatible with the contemporary exterior changes.

Guideline #33: Door and window proportions should relate to the scale and style of the building itself.

The project proposes floor to ceiling windows throughout the building, which is compatible with the horizontal cedar siding and contemporary style. The windows are located to maintain an aesthetic rhythm between voids and solid wall.

Guideline #36: Design a façade to provide visual interest to the street.

The project proposes to use vertical open joint untreated cedar cladding, throughout the building. The project also proposes to replace the windows and remove faux architecture to create visual interest allowing for a contemporary design.

Landscape & Lighting

The project includes landscaping and exterior lighting as shown on the plans. In conformance to the Design Guidelines and all exterior lighting fixtures shall conform to Architectural Design Guidelines #10-12.

Tree Protection

No tree removal is being proposed as part of this project.

Stormwater Treatment Measure

In accordance to the City's National Pollution Discharge Elimination Permit issued by the State Water Board, single-family residences that create and/or replace more than 2,500 square feet (Tier 1) of impervious surface, shall implement the following Low Impact Development (LID) measures:

- Limit disturbance of natural drainage features
- Limit clearing, grading, and soil compaction
- Minimize impervious surfaces
- Minimize runoff by dispersing runoff to landscape or using permeable pavements

The project includes a landscape plan that shows how much of the site will remain in a natural condition.

CALIFORNIA ENVIRONMENTAL QUALITY ACT (CEQA)

In reviewing this action, the City has followed guidelines adopted by the State of California as published in California Administrative Code, Title 14, §15000, et seq. The proposed project is found to be exempt under the CEQA Guidelines Categorical Exemption, Section 15301(e)(1), Class 1, Existing Facilities.

Class 1 consists of existing facilities. The key consideration is whether the project involves negligible or no expansion of an existing use. The proposed alterations do not constitute a substantial adverse change to the structure. The proposed remodel and alterations do not present any unusual circumstances that would result in a potentially significant environmental impact, thus conforming to the requirements of the California Environmental Quality Act (CEQA).

This Class of exemption is subject to exceptions from the exemption under 15300.2 of the CEQA Guidelines pertaining to location, cumulative impacts, significant effects, scenic highways, hazardous waste sites, and historical resources. Staff finds that none of these exceptions applies and that the proposed project qualifies for the Class 1 exemption.

ATTACHMENTS

- A. Application
- B. Project Data Sheet
- C. Draft Permit
- D. CEOA Documentation
- E. Site Plan & Elevations

Lainel O'Halloran

Laurel O'Halloran Associate Planner



Community Development Department – Planning Division

300 Forest Avenue, Pacific Grove, CA 93950

Tel: 831.648.3190 • Fax: 831.648.3184 • www.cityofpacificgrove.org/cedd

Permit Application

Application #

Total Fees:

P-18-1031

Date:

		ppiication			
	Project Address: 12	DS OCEANIV	IEW BONG	EVARD APN:	006012017000
	Project Description:	House	removed		
ER:					
APPLICANT/OWNER:	Tree Work?	☐ Yes	X No		
NT/		pplicant	/ \		Owner
LICA	Name: MARKMUE		n harua Ba	2 Name: STACEY+	JOAO TANG
APP	Phone: 1(45) 31	- 1		Phone: 408 84	()
	Email: MAILO	MCKNH	M. LOM		359@GMAL.COM
	Mailing Address: 54	BRANNA	NST. #30	4 Mailing Address: 1	
	SAN FRANCIS		94107	SAN JOSE	
	Permit Request:			. 0	
	☐ CRD: Counter Determina	ation SP: Sign	Permit	☐ LM: Lot Merger	☐ EIR: Environmental Impact
	AP: Architectural Permit	□ UP: Use	Permit	☐ IHS: Initial Historic Screenin	g 🗆 VAR: Variance
	☐ AAP: Administrative AP	□ AUP: Ad	lministrative UP	☐ HPP: Historic Preservation	☐ MMP: Mitigation Monitoring
	☐ ADC: Arch Design Chang	je 🗆 ADU: Ac	c. Dwelling Unit	☐ A: Appeal	☐ Stormwater Permit
	☐ ASP: Admin Sign Permit	☐ LLA: Lot	Line Adjustment	☐ TPD: Tree Permit W/ Dev't	☐ Other:
ĽY:	CEQA Determination:	Review A	uthority:	Active Permits:	Overlay Zones:
S	₩ Exempt	☐ Staff	☐ HRC	☐ Active Planning Permit	☐ Butterfly Zone
JSE	☐ Initial Study & Mitigated	— — -		☐ Active Building Permit	☐ Coastal Zone
H	Negative Declaration Environmental Impact	□ SPRC		☐ Active Code Violation	Significance (ASBS)
TA	Report	ARB		Permit #:	☐ Environmentally Sensitive
NG S					Habitat Area (ESHA)
LANNING STAFF USE ONLY:	Property Information Lot: 2		Block: 350	Tract	Fairway Homes
PL	zc: <u>R-1-H</u>	_	GP: MD (17.4		ze: 10,335,62#
	☐ Historic Resources Inventory RECE Avchaeologically Sensitive Area				
	D. A. T.				
	Staff Use Only:	DE	C 2 0 2018	SPAID	
	Received by:AO			+ 3,728.29	
	Assigned to:	<u>CITY OF I</u>	PACIFIC GRO	VE 12-20-18	
CEI	TIFICATION — I. the undersi	gped, under penal	ty of perjury, depos	e and certify that I am the applica	nt for this request, that the property
ow	ner approves this applicatio	n and that all state	ements contained h	erein, including all documents and	d plans submitted in connection with
this	s application, are true and a	gurate to the best	of my knowledge.		

I further acknowledge it is my esponsibility to determine whether additional permits are required.

Applicant Signature:

Owner Signature (Required):

Date: 02/27/2018

Updated: 08/17/2017

PROJECT DATA SHEET

Project Address: 1205 Ocean View Boulevard Submittal Date: 12/19/2018 (Update May 2019)

Applicant(s): Mark Mueckenheim & Maria Paz Permit Type(s) & No(s): AP-18-1031 Architectural Permit

	REQUIRED/ Permitted	Existing Condition	Proposed Condition	Notes
Zone District	R-1-H	R-1-H	R-1-H	(SINGLE FAMILY RESIDENTIAL DISTRICT)
Building Site Area	10476.89 sqft	10476.89 sqft	10476.89 sqft	
Density (multi-family projects only)				
Building Coverage	35%	2982,40 sqft	2982.40 sqft2	Mallowed 3,667sf
Site Coverage	60%	28.47%	28.47%	
Gross Floor Area	3,390 sqft	5057.00 sqft	5057.00 sqft	
Square Footage not counted towards Gross Floor Area	0 sqft			
Impervious Surface Area Created and/or Replaced	6285.60 sqft in total =60%	5582.37 sqft = 53.28%	5582.37 sqft = 53.28%	Brick Decking is Pervious
Exterior Lateral Wall Length to be demolished in feet & % of total*		3372' 6.361"	23' 6.716" 8.37%	Removal of two bay windows
Exterior Lateral Wall Length to be built			18' 9.776°	Sliding Glass Doors (replacing bay windows)
Building Height	19'5.76"	19'5.76"	19'5.76"	Capacital Basi, managing
Number of stories		2	2	
Front Setback	12ft	12ft	12ft	
South Eastern Side Setback (specify side)	20% or 15'Maximum	20% or 15'Maximum	20% or 15'Maximum	
North Western Side Setback (specify side)	10% = 9ft	10% = 9ft	10% = 9ft	
Rear Setback	8ft	8ft	8ft	
Garage Door Setback	20ft	20'10.203"	20'10.203"	
Covered Parking Spaces	3	3	3	
Uncovered Parking Spaces	4	4	4	
Parking Space Size (Interior measurement)	9' x 20'	2x > 9'x20' 1x = 9'x17.5'	2x > 9'x20' 1x = 9'x17.5'	One parking space is shorter
Number of Driveways	1	1	1	Driveway width for 3 car
Driveway Width(s)	28'7.2"	28'7.2"	28'7.2"	
Back-up Distance		20'10.203"	20'10.203"	
Eave Projection (Into Setback)	3' maximum	0	0	
Distances Between Eaves & Property Lines	3' minimum	9'2.84" +	11'5.16" +	
Open Porch/Deck Projections		max. 7' 11.78'		
Architectural Feature Projections		654 sqft	157 sqft	Roof Overhang
Number & Category of Accessory Buildings		0	0	
Accessory Building Setbacks				n/a
Distance between Buildings				n/a
Accessory Building Heights				n/a
Fence Heights		6' and 4' or less	6' and 4' or less	will be lowered were necessary please see plan

^{*}If project proposes demolition to an HRI structure, also indicate % of proposed demolition of the surface of all exterior walls facing a public street or streets, if applicable.



Community Development Department - Planning Division

300 Forest Avenue, Pacific Grove, CA 93950 T: 831.648.3183 • F: 831.648.3184 • www.ci.pg.ca.us/cdd

ARCHITECTURAL PERMIT (AP) 18-1031 FOR A PROPERTY LOCATED AT 1205 OCEAN VIEW BOULEVARD TO ALLOW A COMPREHENSIVE EXTERIOR REMODEL

FACTS

- 1. The subject site is located at 1205 Ocean View Boulevard (APN 006-012-017)
- 2. The subject site has a designation of Medium Density to 17.4 DU/AC on the adopted City of Pacific Grove General Plan Land Use Map.
- 3. The subject site is located in the R-1-H zoning district.
- 4. The subject site is approximately 10,335 sf with a 5,057 sf two- story single family dwelling.
- 5. The property is located in an archaeologically sensitive area and in the Area of Special Biological Significance (ASBS), and is not the Historic Resources Inventory.
- 6. This project has been determined to be CEOA Exempt under CEOA Guidelines, Section 15301(a)(1), Class 1

FINDINGS

- 1. The proposed development will meet the development regulations set forth in the R-1-H zoning district including setbacks and height requirements and;
- 2. The architecture and general appearance of the completed project is compatible with the neighborhood because the proposed exterior will be compatible with the size, scale and proportions of the existing residence and other residences in the neighborhood, in that the proposal is consistent with Architectural Review Guidelines 12,33, 36 and:
- 3. The completed project will neither be detrimental to the orderly and harmonious development of the city nor impair the desirability of investment or occupation in the neighborhood because the project will be improving the subject property; and
- 4. The Board have been guided by and made reference to applicable provisions of the Architectural Review Guidelines in making its determinations on single-family residences.

PERMIT

Architectural Permit (AP) 18-1031 to allow a comprehensive exterior remodel.

CONDITIONS OF APPROVAL

- 1. **Permit Expiration.** This permit shall expire and be null and void if a building permit has not been applied for within TWO (2) years from and after the date of approval. Application for extension of this approval must be made prior to the expiration date.
- 2. **Construction Compliance.** All construction must occur in strict compliance with the proposal as set forth in the application, subject to any special conditions of approval herein. Any deviation from approvals must be reviewed and approved by staff, and may require Architectural Review Board approval.
- 3. **Terms and Conditions**. These terms and conditions shall run with the land, and it is the intention of the Community Development Director and the Permittee to bind all future owners and possessors of the subject property to the terms and conditions, unless amended. Amendments to this permit may be achieved only if an application is made and approved, pursuant to the Zoning Code.
- 4. **Public Works, Fire and Building.** Review and approval by the Public Works, Fire and Building Departments are required prior to issuance of a building permit. Work taking place in the public right-of-way shall require an encroachment permit prior to issuance of the building permit.

- 5. **Tree Protection Standards During Construction**. Pursuant to Municipal Code Chapters 12.20 and 12.30, and the *Urban Forestry Standards*, all trees that are otherwise protected and will be impacted as a result of Development, both proposed for pruning or removal and where the development will impact the critical root zone of the tree are protected. Prior to issuance of the building permit, the Project Arborist shall review grading, drainage, utility, building and landscape plans to determine impacts to individual Trees, to determine required minimum Tree protection standards during construction.
- 6. **Stormwater Treatment Measure.** The stormwater treatment measures shall be maintained by the property owner in perpetuity and City of Pacific Grove staff shall be allowed access to inspect all stormwater treatment measures on an annual basis.
- 7. **Lighting**. All exterior lighting must conform to Architectural Review Guidelines Nos. 10,11,12
- 8. **Archeology.** If archaeological resources or human remains are discovered during construction, work shall be halted within 50 meters of the find until it can be evaluated by a qualified professional archaeologist. If the find is determined to be significant, appropriate mitigation measures shall be formulated, with the concurrence of the City of Pacific Grove staff, and implemented.
- 9. **Building Plans.** All conditions of approval for the Planning permit(s) shall be printed on a full size sheet and included with the construction plan set submitted to the Building Department.

NOW, THEREFORE, BE IT RESOLVED BY THE ARCHITECTURAL REVIEW BOARD OF THE CITY OF PACIFIC GROVE:

- 1. The Board determines that each of the Findings set forth above is true and correct, and by this reference incorporates those Findings as an integral part of this Permit.
- 2. The Board authorizes Approval of Architectural Permit (AP) 18-1031 as conditioned and pursuant to a Class 1, Section 15301, CEQA categorical exemption for Existing Facilities.
- 3. This permit shall become effective upon the expiration of the 10-day appeal period.
- 4. This permit shall not take effect until the owner acknowledges and agrees to all terms and conditions and agrees to conform to and comply with those terms and conditions.

PASSED AND ADOPTED AT A REGULAR MEETING OF THE ARCHITECTURAL REVIEW BOARD OF THE CITY OF PACIFIC GROVE ON THE 9th DAY OF JULY, 2019, BY THE FOLLOWING VOTE:

AYES:	
NOES:	
ABSENT:	APPROVED:
ABSTENTIONS:	Sarah Boyle, Chair
The undersigned hereby acknowledge and agree to the approcomply with, said terms and conditions.	oved terms and conditions, and agree to fully conform to, and
Stacey Tang, Owner	Date
Page 2 of 2	Permit No. AP 18-1031



Community Development Department - Planning Division

300 Forest Avenue, Pacific Grove, CA 93950

T: 831,648.3190 • F: 831.648.3184 • www.ci.pg.ca.us/cdd

NOTICE OF EXEMPTION FROM CEQA

Property Address/Location: 1205 Ocean View Blvd, Pacific Grove, CA 93950

Project Description: AP 181031

Description: Remodel and facade updates

APN: 006012017000

ZC: R-1-H Lot Size: 10,335.624

Applicant Name:

Mark Mueckenheim

Phone #: 415-316-9029

Mailing Address:

542 Brannan St #304 San Francisco, CA 94107

Email Address:

mail@mcknhm.com

	Public Agency Approving Project: City of Pacific Grove, Monterey County, California
Exempt	t Status (Check One):
☐ Mini	sterial (Sec. 21080(b)(1):15268))
Dec	lared Emergency (Sec. 21080(b)(3): 15269(a))
□ Eme	ergency Project (Sec. 21080(b)(4); 15269(b)(c))
② Cate	egorical Exemption Type and Section Number: 15301(a)(1)
☐ Stat	utory Exemption Type and Section Number:
☐ Othe	er:
Existing	tion Findings: Facilities. The proposed alterations do not present any unusual circumstances that would result in a ly significant environmental impact. This Class of exemption is subject to exceptions from the exemption

under 15300.2 of the CEQA Guidelines pertaining to location, cumulative impacts, significant effects, scenic highways, hazardous waste sites, and historical resources. Staff finds that none of these exceptions applies and

Contact: Laurel OHalloran, Planning Department, City of Pacific Grove

that the proposed project qualifies for the Class 1 exemption.

Contact Phone: (831) 648-3183

Signature:

James Oftallam

Date: July 9,201

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Project Team

Architectural Design: Mark Mueckenheim and Maria Paz Staff Members: Jing Zhang / Kawinthra Chongsuksantikul

Address:

MCKNHM Architekten & RIZOMA Arquitetura 912 Sonora Ave Half Moon Bay CA 94019 - 4223

Project Contact: tang-oceanview@mcknhm.com General Contact: mail@mcknhm.com Phone: 1 (415) 316 9029

Client/Owner:

Stacey and Joao Tang

Drawing List

Architectural: A0.0 TITLE SHEET A0.1 PERMIT DATA **A0.2 ABBREVIATIONS** A0.3 NOTES & LEGEND A0.4 EXISTING SITUATION (PHOTOS) A0.5 DESIGN VISUALIZATIONS (IMAGES) A0.6 DESIGN VISUALIZATIONS (IMAGES)

A1.1 EXISTING SITE PLAN A1.2 PROPOSED SITE PLAN A1.3 EXISTING SIMPLE SITE PLAN A1.4 PROPOSED SIMPLE SITE PLAN A1.5 SITE PLAN FOR CALCULATIONS **A2.1 EXISTING PLANS A2.2 EXISTING PLANS** A2.3 PROPOSED PLANS A2.4 PROPOSED PLANS


A3.1 EXISTING & PROPOSED ELEVATIONS NORTH A3.2 EXISTING & PROPOSED ELEVATIONS WEST A3.3 EXISTING & PROPOSED ELEVATIONS SOUTH A3.4 EXISTING & PROPOSED ELEVATIONS EAST

A4.1 EXISTING & PROPOSED LONGITUDINAL BUILDING SECTION A-A A4.2 EXISTING & PROPOSED CROSS BUILDING SECTION B-B

A5.1 NEW FACADE DETAIL AND ENLARGED ELEVATION A5.2 MATERIAL ELEVATIONS

Project: Contemporary

Cottage House Remodel for Stacey and Joao Tang

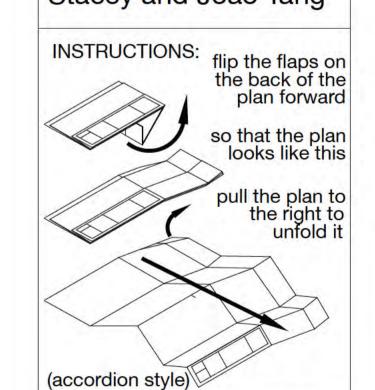

Title Sheet

SCALE: AS NOTED DRAWN BY: MMM UP-DATE: 01|16|19



34"

25.5"

17"


8.5"

4.25"

Contemporary Cottage House Remodel for

Project:

Stacey and Joao Tang

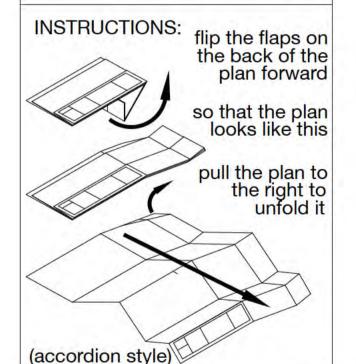

Permit Data

SCALE: AS NOTED DRAWN BY: MMM DATE: 06|17|18

MCKNHM RIZOMA

4.25"

THE SCOPE OF WORK UNDER THIS BUILDING PERMIT SHALL INCLUDE THE RENOVATION OF THE EXISTING HOUSE.

25.5"

Site Address: 1205 Ocean View Boulevard City: Pacific Grove

Zip Code: 93950 County: Monterey County APN: 006012017000

Project Data (Legal):

Project Scope:

Zoning R-1-H (SINGLE FAMILY RESIDENTIAL DISTRICT)

Building Setbacks: Front Setback: 12 feet

Rear Setback: 1 Story = 5 feet 2 Story = 8 feet

Side Setback: 10% of lot width / East (corner): 20% or 15ft Maximum

Building: Existing: Proposed: Lot Area (Sq. Ft.): 10476.89 SF 10476.894 SF Building Size (Sq. Ft.): 4343.00 SF 4343.00 SF Garage (Sq. Ft.): 714.00 SF 714.00 SF Unfinished Sq. Ft.:

Building Type: Single Family Residence

Building Sequence Number: 1

Quality Class: D8.5 Year Built: 1987 Effective Year: 1987

Maximum height allowed: 25 feet

	Existing:	Proposed:
Building Height:	19'5.76"	19'5.76"
Roof Overhang:	654 SqFt	157 SqFt
Unit Coguenea Number	4	

Unit Sequence Number: 1 Unit Size (Sq. Ft.): 4343

	Existing:	Proposed:	
Number of Bedrooms:	7	5	
Number of Full Bathrooms:	7	7	
Number of Half Bathrooms:	0	0	
Number of Kitchens:	1	1	
Number of halfKitchens/Bars	2	2	
Number of Fireplaces:	2	3	

Archaeological Zone: Yes / but archaeological assesment

already conducted and approved

Coastal Zone: No

Historic Resources Inventory: No

Area of Special Biological Significance Watershed: Yes

Butterfly Habitat: No

Environmentally Sensitive Habitat Area: No

Septic: No

Runoff Retention Required: No

Land Use: Med Dens to 17.4 DU/ac

Lot/Block: FAIRWAY HOMES TRACT LOT 2 BLK 356

17"

Tract: Beach Tract / Fairway Homes

APPLICABLE BUILDING CODES:

ALL WORK NOTED SHALL BE IN FULL ACCORD AND COMPLY WITH THE LATEST RULES, REGULATIONS, ORDINANCES, CODES AND STANDARDS LISTED BELOW AND ANY AND ALL LOCAL CODES AND ORDINANCES CURRENTLY IN EFFECT IN THE CITY OF PACIFIC GROVE

2013 CALIFORNIA BUILDING CODE (CBC) 2013 CALIFORNIA RESIDENTIAL CODE (CRC) 2013 CALIFORNIA GREEN BUILDING CODE (CGBC) 2013 CALIFORNIA PLUMBING CODES (CPC) 2013 CALIFORNIA MECHANICAL CODE (CMC) 2013 CALIFORNIA ELECTRICAL CODE (CEC) 2013 CALIFORNIA ENERGY CODE 2013 CALIFORNIA ENERGY EFFICIENCY STANDARDS

34"

11" Project: Contemporary Cottage House Remodel for Stacey and Joao Tang INSTRUCTIONS: flip the flaps on the back of the plan forward so that the plan looks like this pull the plan to the right to unfold it

Item No. 7B

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4.25"

34"

34"

4.25"

Abbreviations

NO SCALE

DRAWN BY: MMM

DATE: 06|18|18

(accordion style)

MCKNHM

General Notes and Conditions:

- 1. Notify architectural designer promptly if any conditions conflict with construction documents.
- 2. Field verify all existing conditions and dimensions prior to fabrication/ construction.
- 3. Notify architectural designer any discrepancies between documents, including discrepancies between engineering documents and construction documents.
- 4. Provisions shall be made for the undergrounding of all utilities serving the property, including but not limited to electrical, telephone, and cable television, by the installation of appropriately sized underground conduits extending from the street property, as per BBC 705A.1.
- 5. All persons working at this site must implement applicable portions of the State Storm Water Best Management Practices Manual for Construction to the maximum extent practicable to prevent erosion and sediment from entering into the storm drain system. Failure to utilize adequate controls is a violation of BMC 17.20. A copy of the manual is available upon request at the Permit Service Center and available online at www.cabmphandbooks.com.
- 6. Approval of this permit for work in the public right-of-way or easement does not relieve the applicant of the responsibility of obtaining permission to enter neighboring as a license to alter or adversely impact any facilities located in these easements which are privately owned. Full restitution and restoration shall be the responsibility of OPENING the permittee. Permittee shall notify property owner of intentions 72 hrs prior to entering the property.
- 7. This is a permit set of design drawing not intended for the actual construction.

Dimensioning Conventions:

1. DIMENSIONS AS NOTED IN THE PLANS SHALL TAKE PRECEDENCE OVER SCALED DIMENSIONS.

17"

- 2. DIMENSIONS ARE FROM GRID LINE TO FACE OF CONCRETE OR STUD ON PLANS AND FACE OF FINISH ON ALL OTHER DRAWINGS, UNLESS OTHERWISE NOTED. ANY ERRORS, OMMISSIONS, OR AMBIGUITIES IN THE PLANS ARE TO BE REPORTED TO THE ARCHITECTURAL DESIGNER BEFORE PROCEEDING WITH THE WORK. SEE ENLARGED PLANS, FOR ADDITIONAL DIMENSIONS & INFORMATION.
- 3. DETAILS SHALL GOVERN OVER PLANS AND ELEVATIONS. LARGE SCALE PLANS GOVERN OVER SMALL SCALE PLANS. LARGE SCALE DETAILS SHALL GOVERN OVER SMALL SCALE DETAILS. IF UNABLE TO LOCATE THE DIMENSIONS FOR ANY ITEM OF WORK, CONSULT THE ARCHITECT PRIOR TO CONSTRUCTION.
- 4. ALL DIMENSIONS ON ELEVATIONS ARE INDICATED FROM FINISH FLOOR ELEVATION TO FIXTURE AND/OR FINISH WALL UNLESS OTHERWISE NOTED.
- 5. ALL HEIGHTS ARE DIMENSIONED FROM THE TOP OF PLYWOOD OR SLAB, UNLESS NOTED "A.F.F."
- 6. DIMENSIONS ARE NOT ADJUSTABLE, UNLESS NOTED (+/-), WITHOUT ARCHITECT'S WRITTEN APPROVAL.
- . EXCEPT WHERE SPECIFICALLY NOTED TO THE CONTRARY, ALL DIMENSIONS SHOWN ON THE property or properties in the course of this work if necessary. It shall not be construed ARCHITECTURAL DRAWINGS CONFORM TO THE FOLLOWING CONVENTIONS: - STRUCTURAL OR DIMENSIONAL GRID LINES - CENTERLINE OF STEEL - CENTERLINE OF DOOR, WINDOW, OR CASED
 - 8. WHERE WALLS AND / OR PARTITIONS OF UNEQUAL THICKNESS ABUT, ALIGN EXPOSED FACES, UNLESS OTHERWISE NOTED.

8.5"


Project: Contemporary

House Remodel for

INSTRUCTIONS: flip the flaps on the back of the

MCKNHM

Project Symbols:

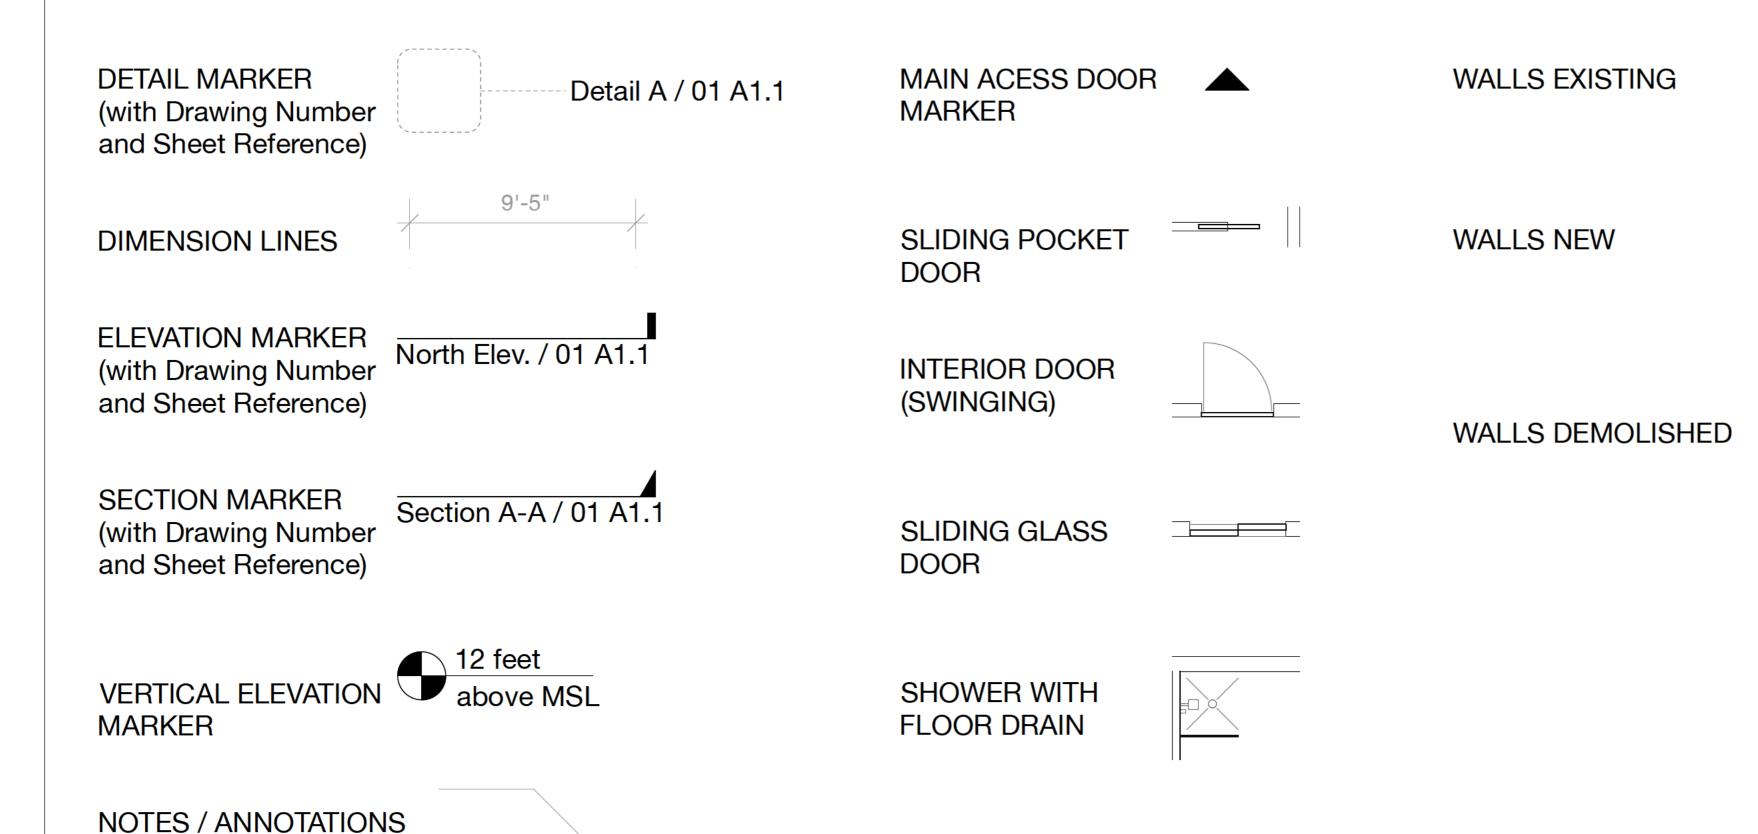

Cottage Stacey and Joao Tang so that the plan looks like this pull the plan to the right to unfold it (accordion style) Notes and Legend **NO SCALE** DRAWN BY: MMM DATE: 06|18|18

22"





























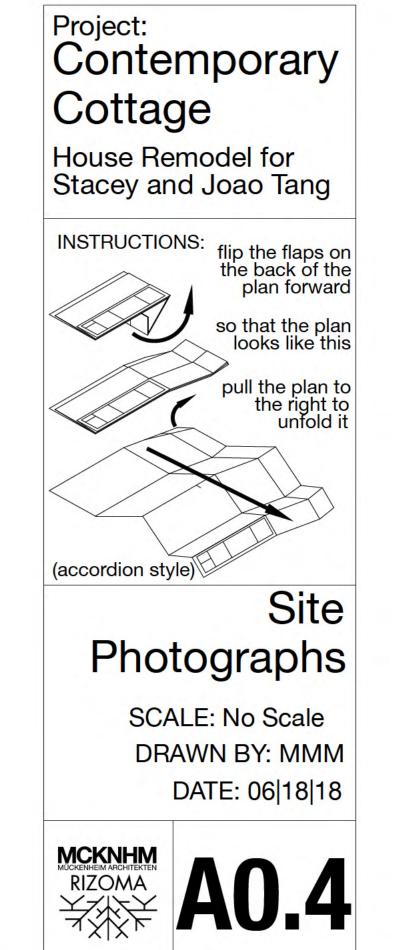

22"





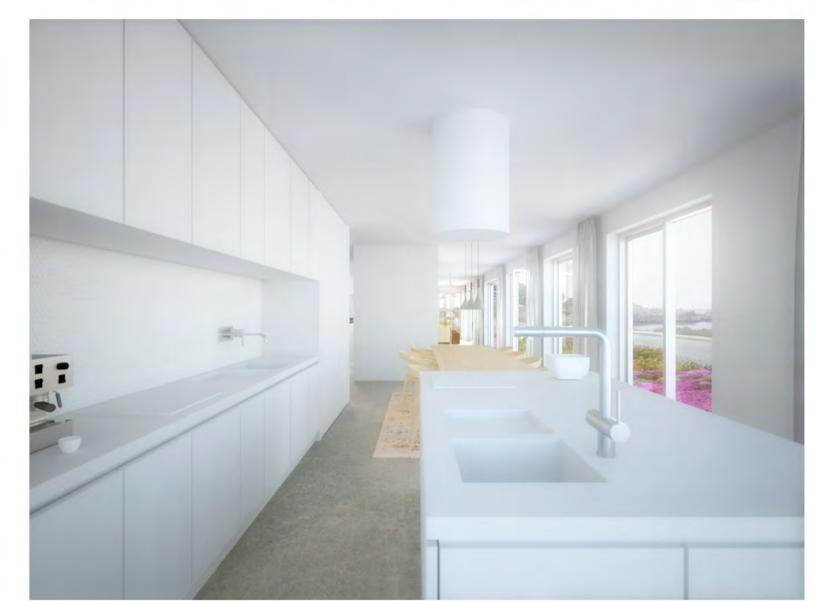














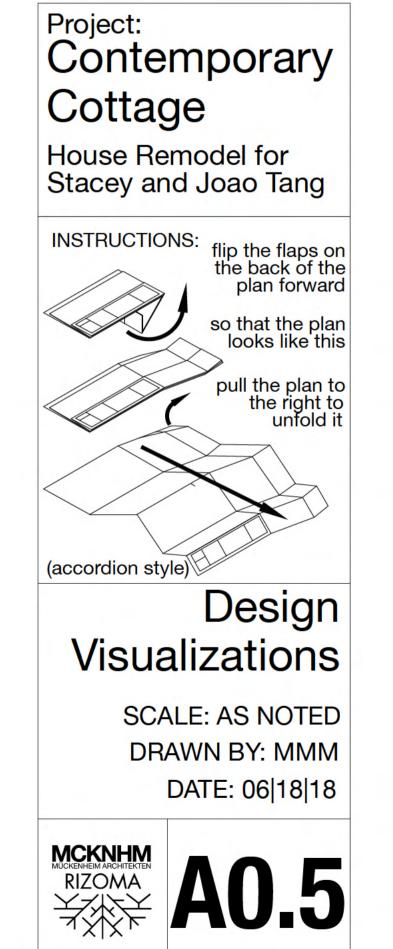


34"


25.5"


17"


9.5"


4.25"

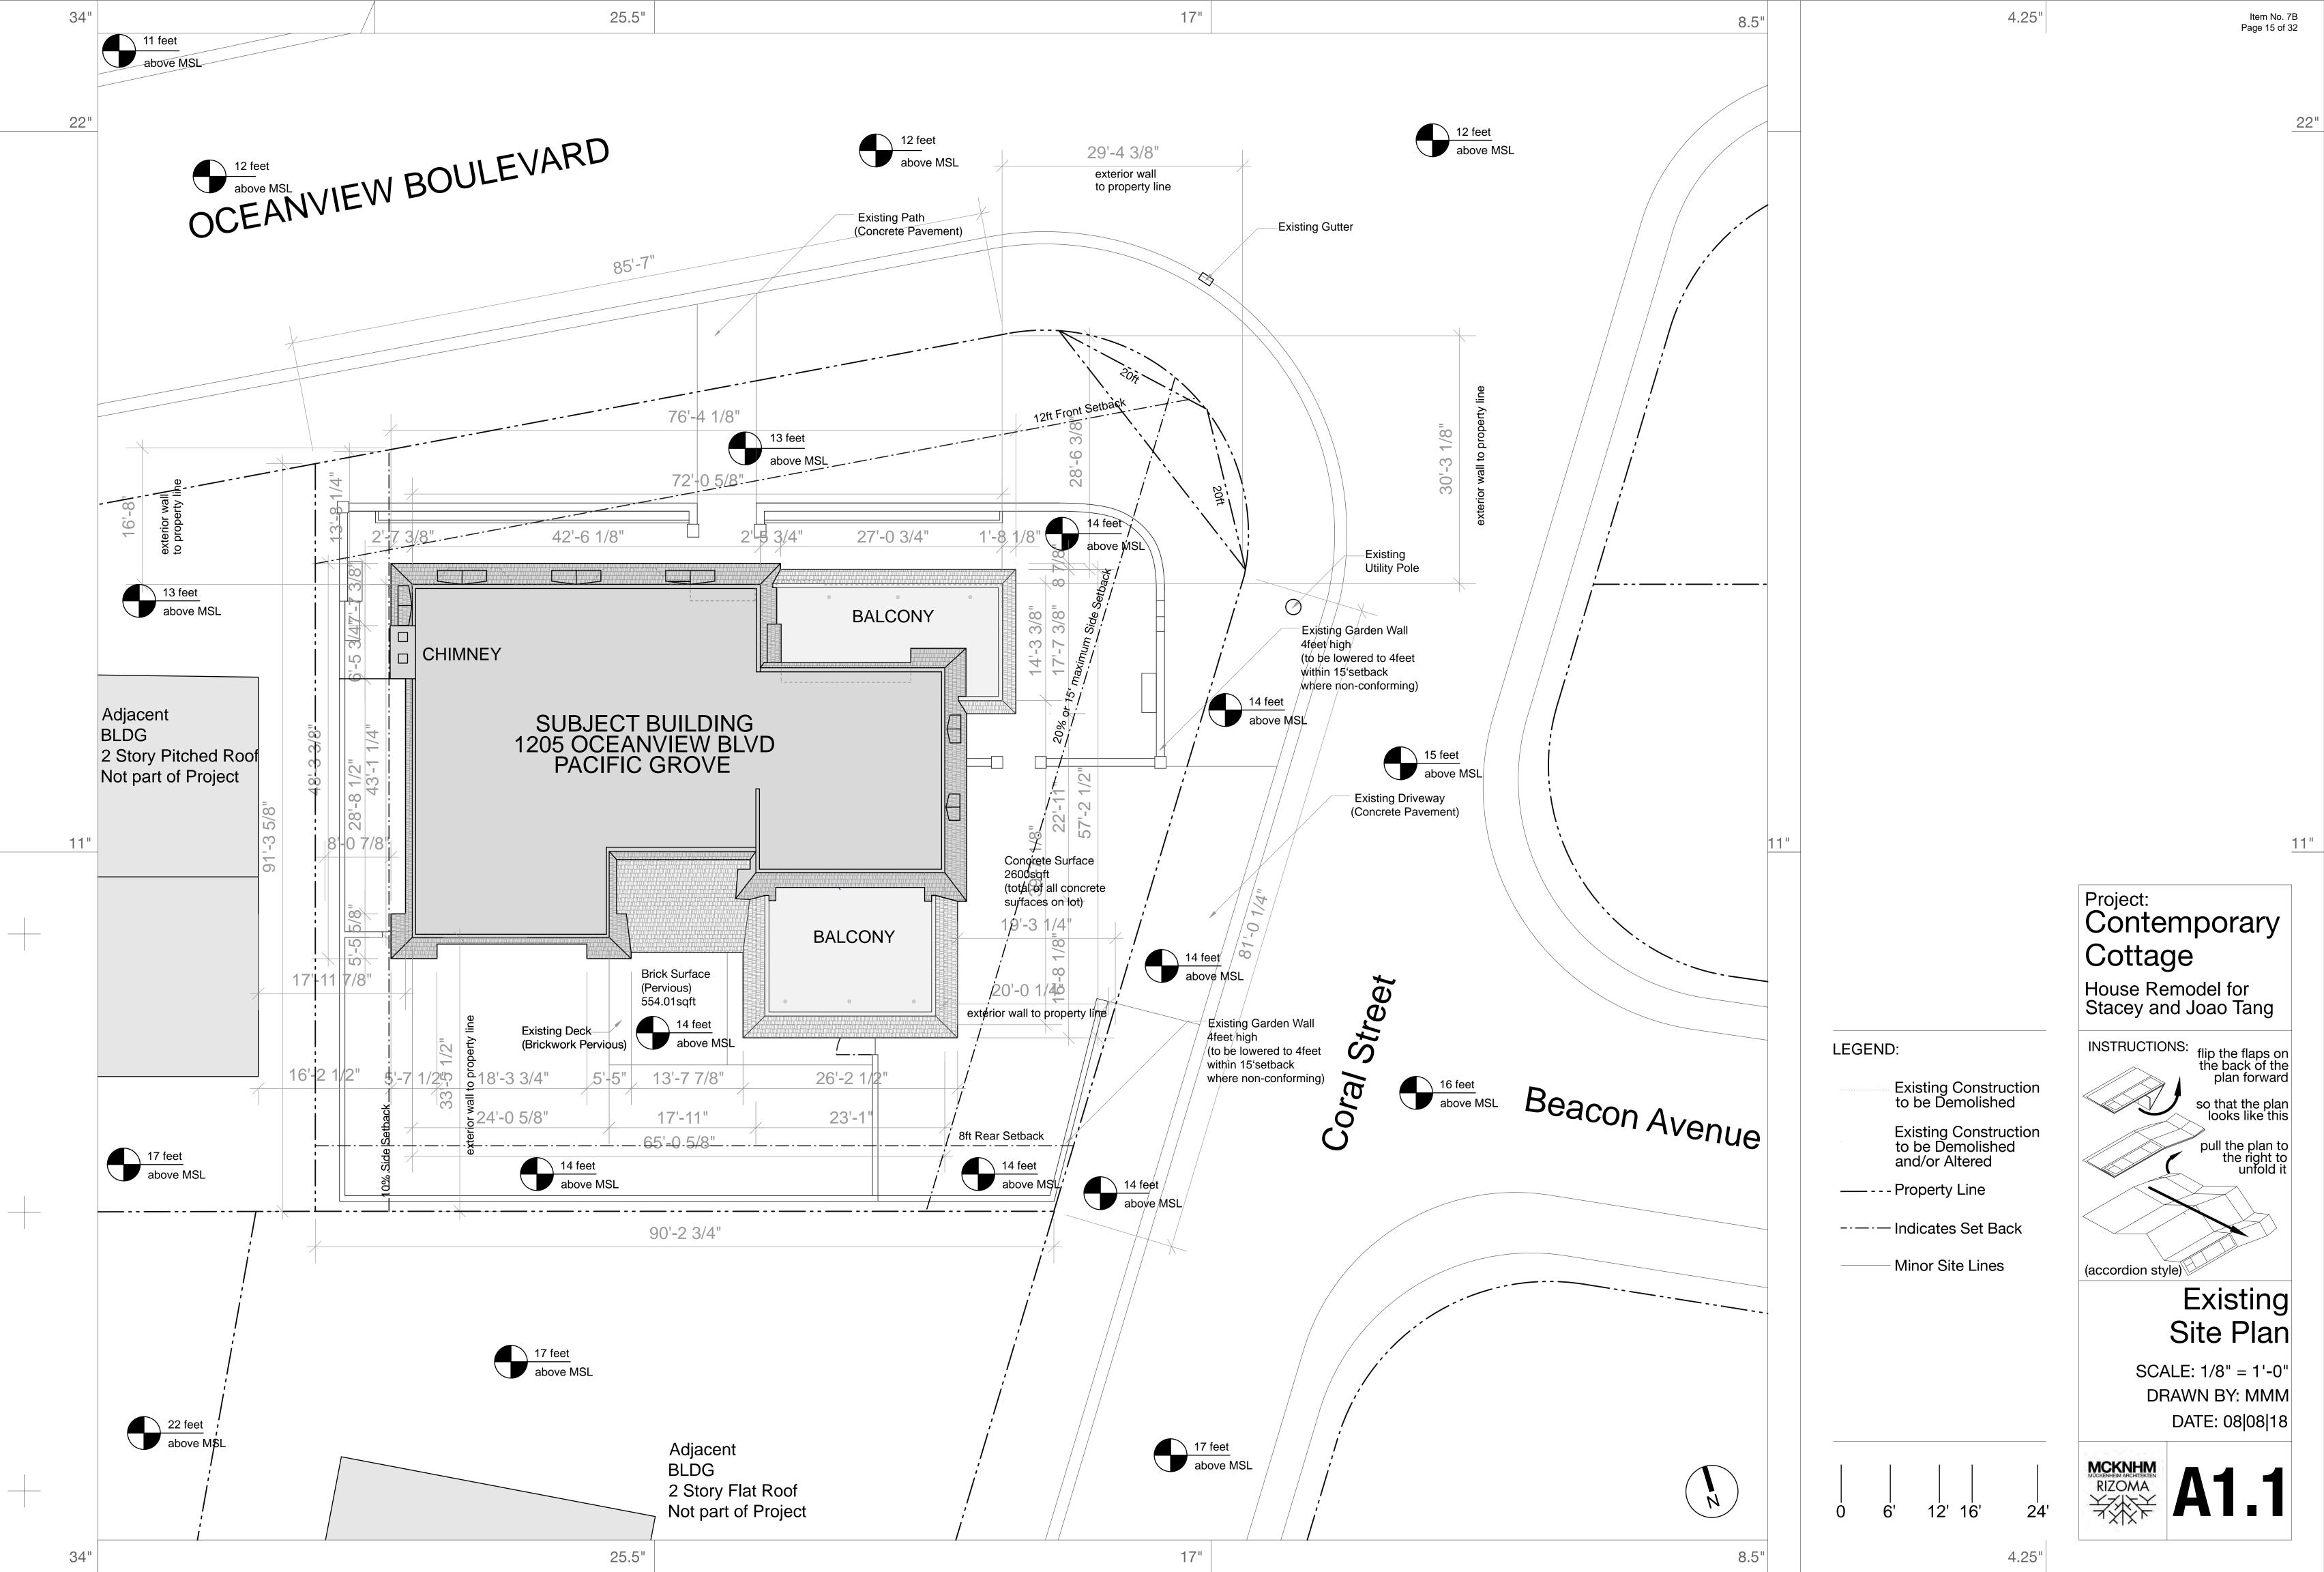


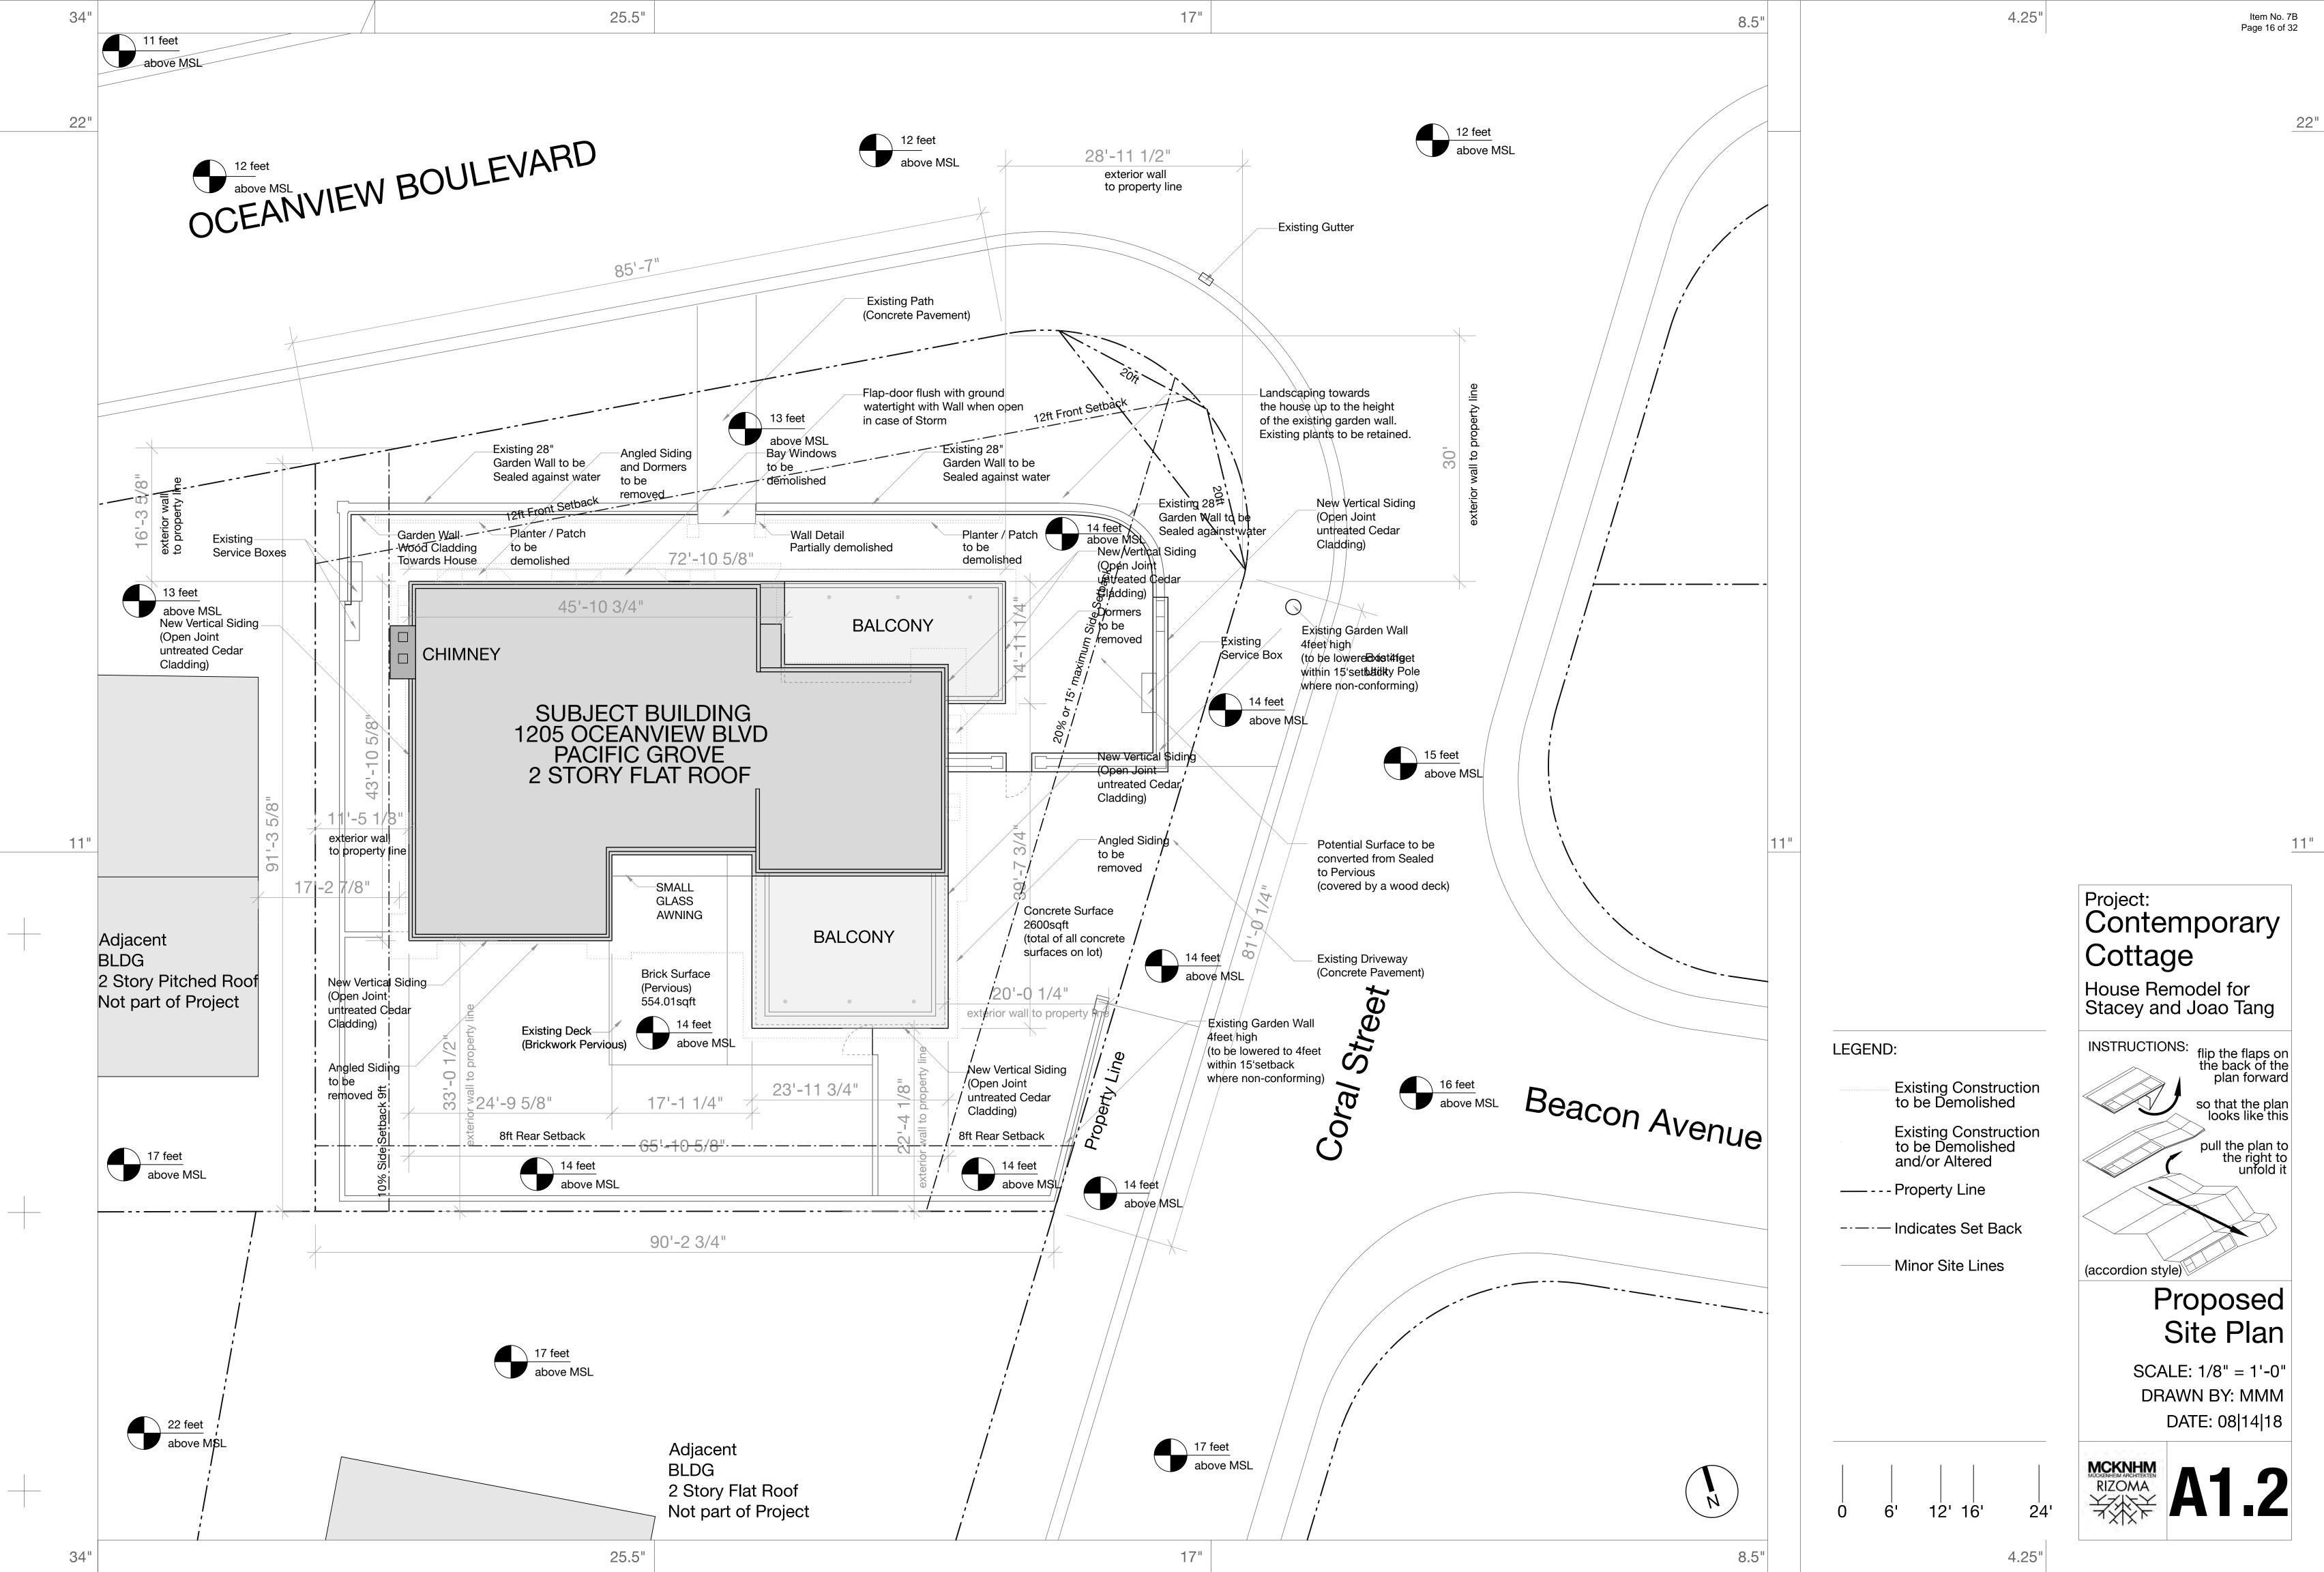


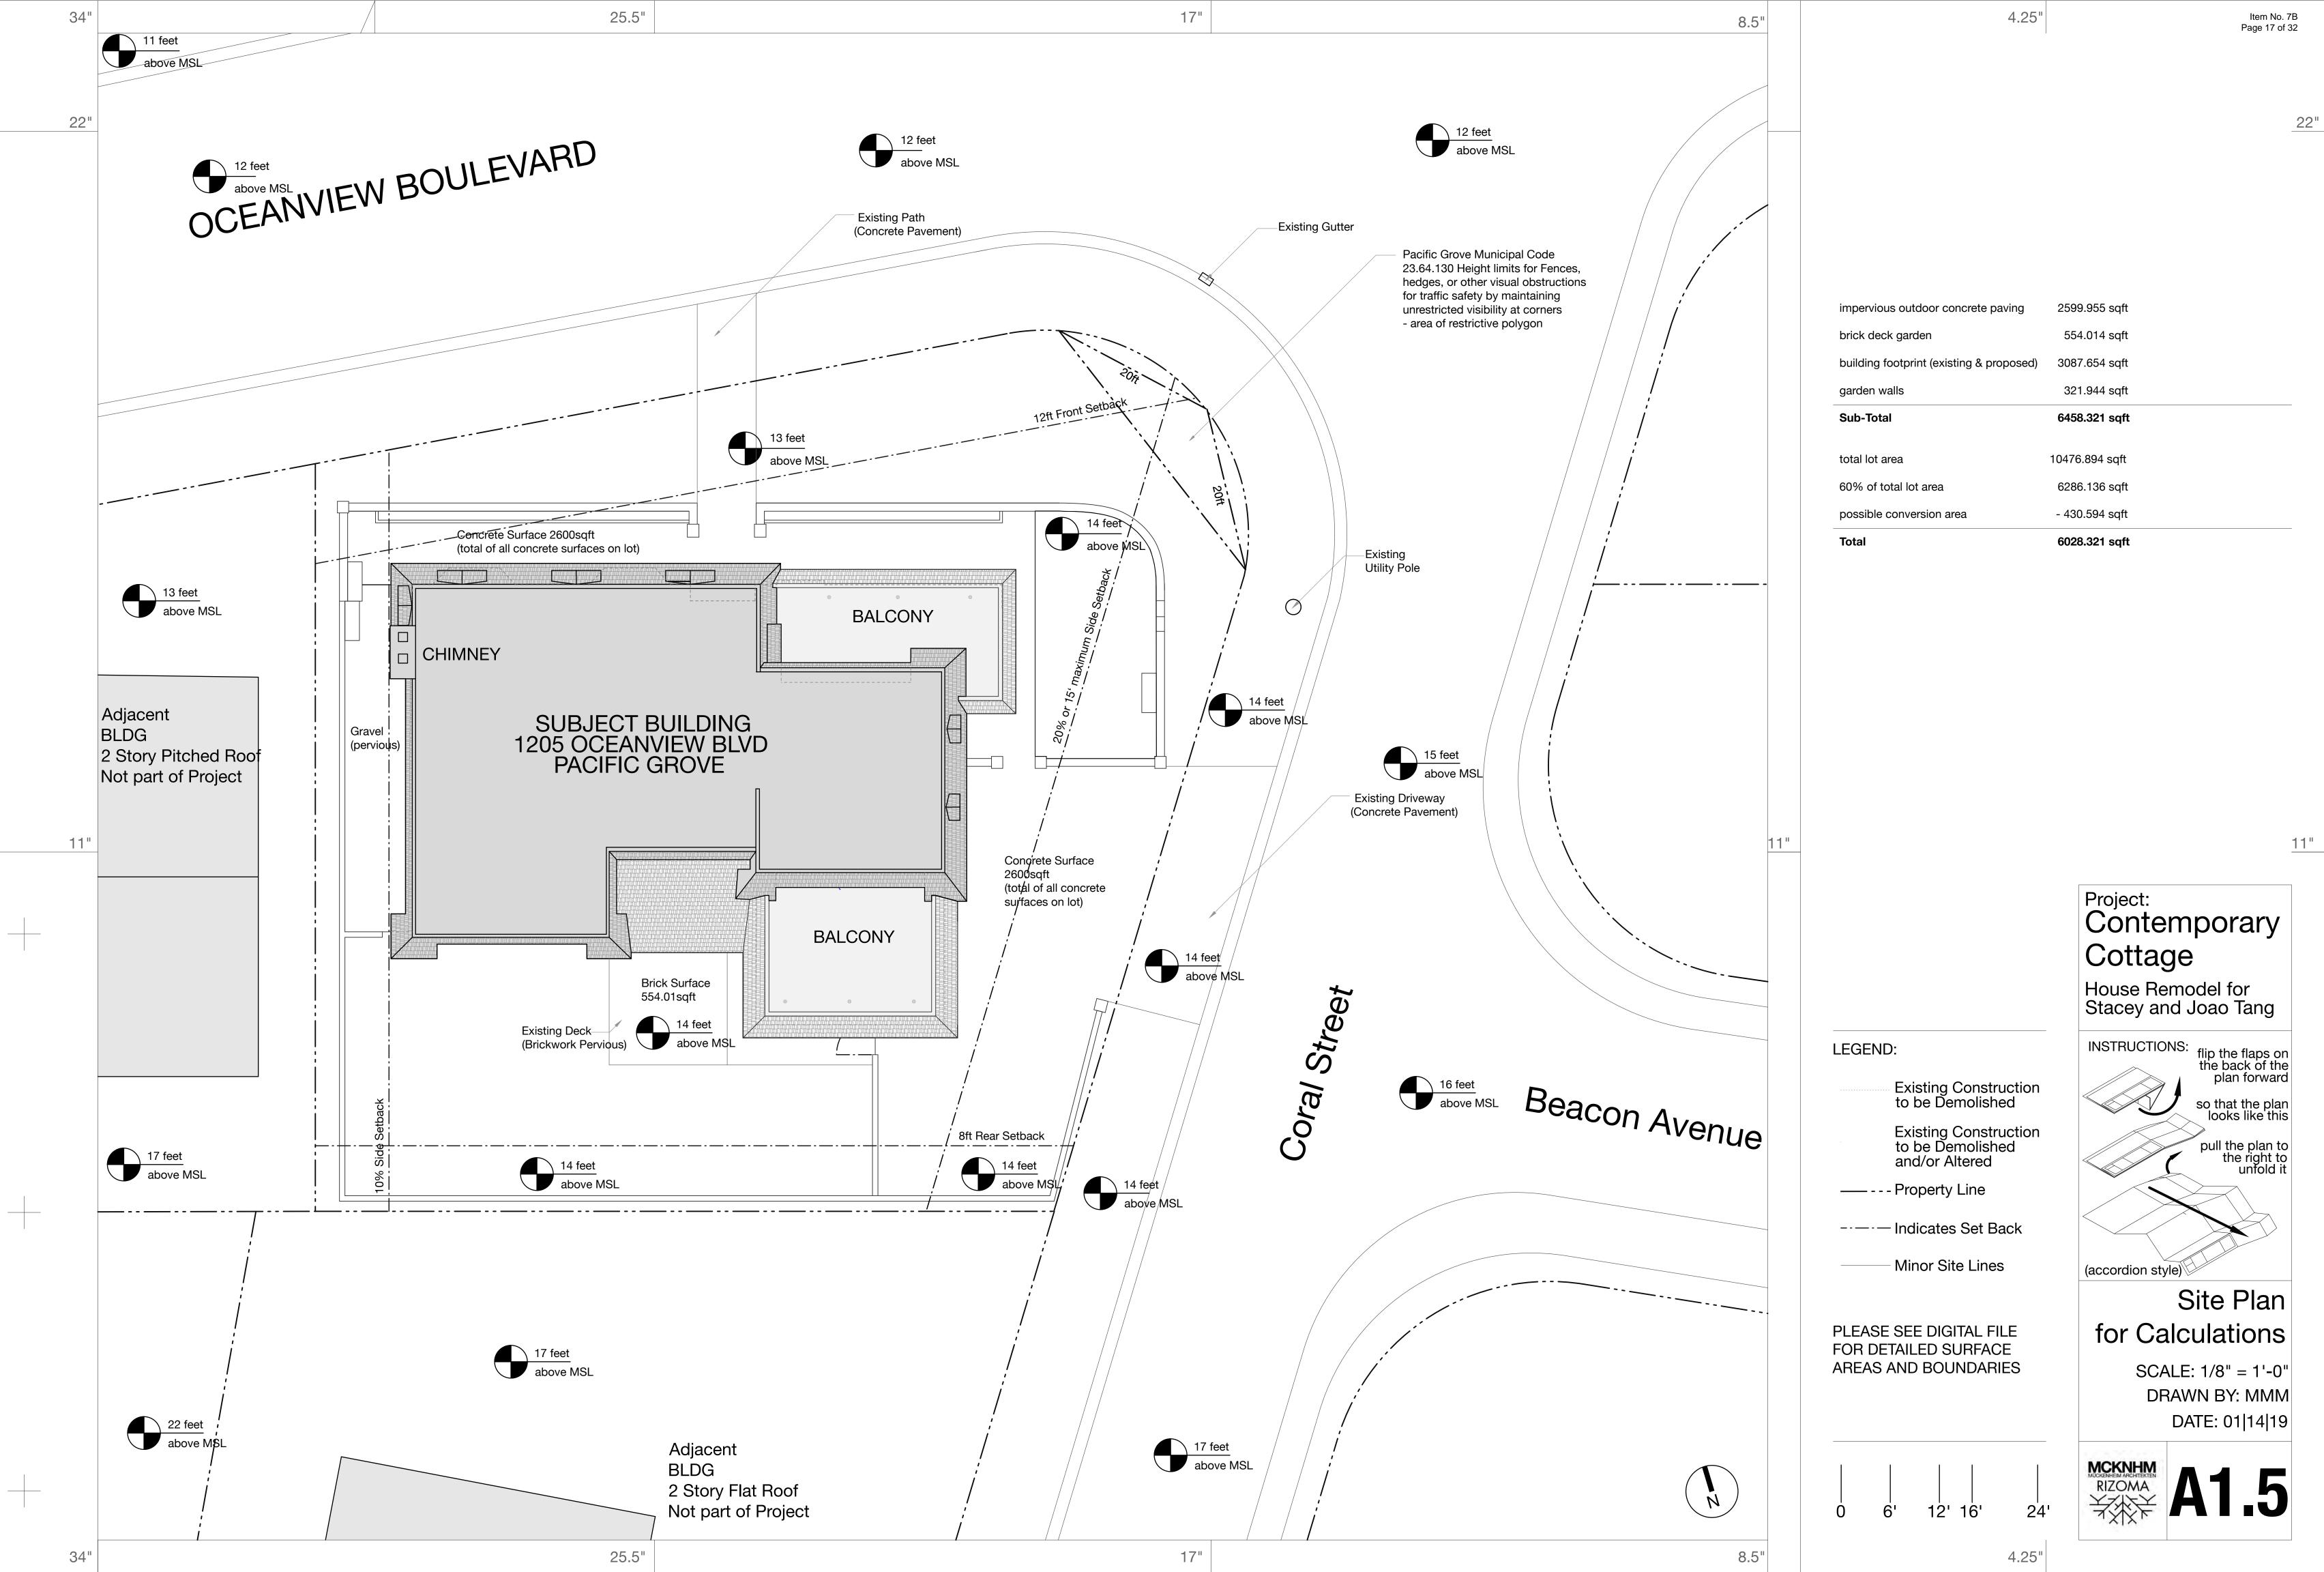


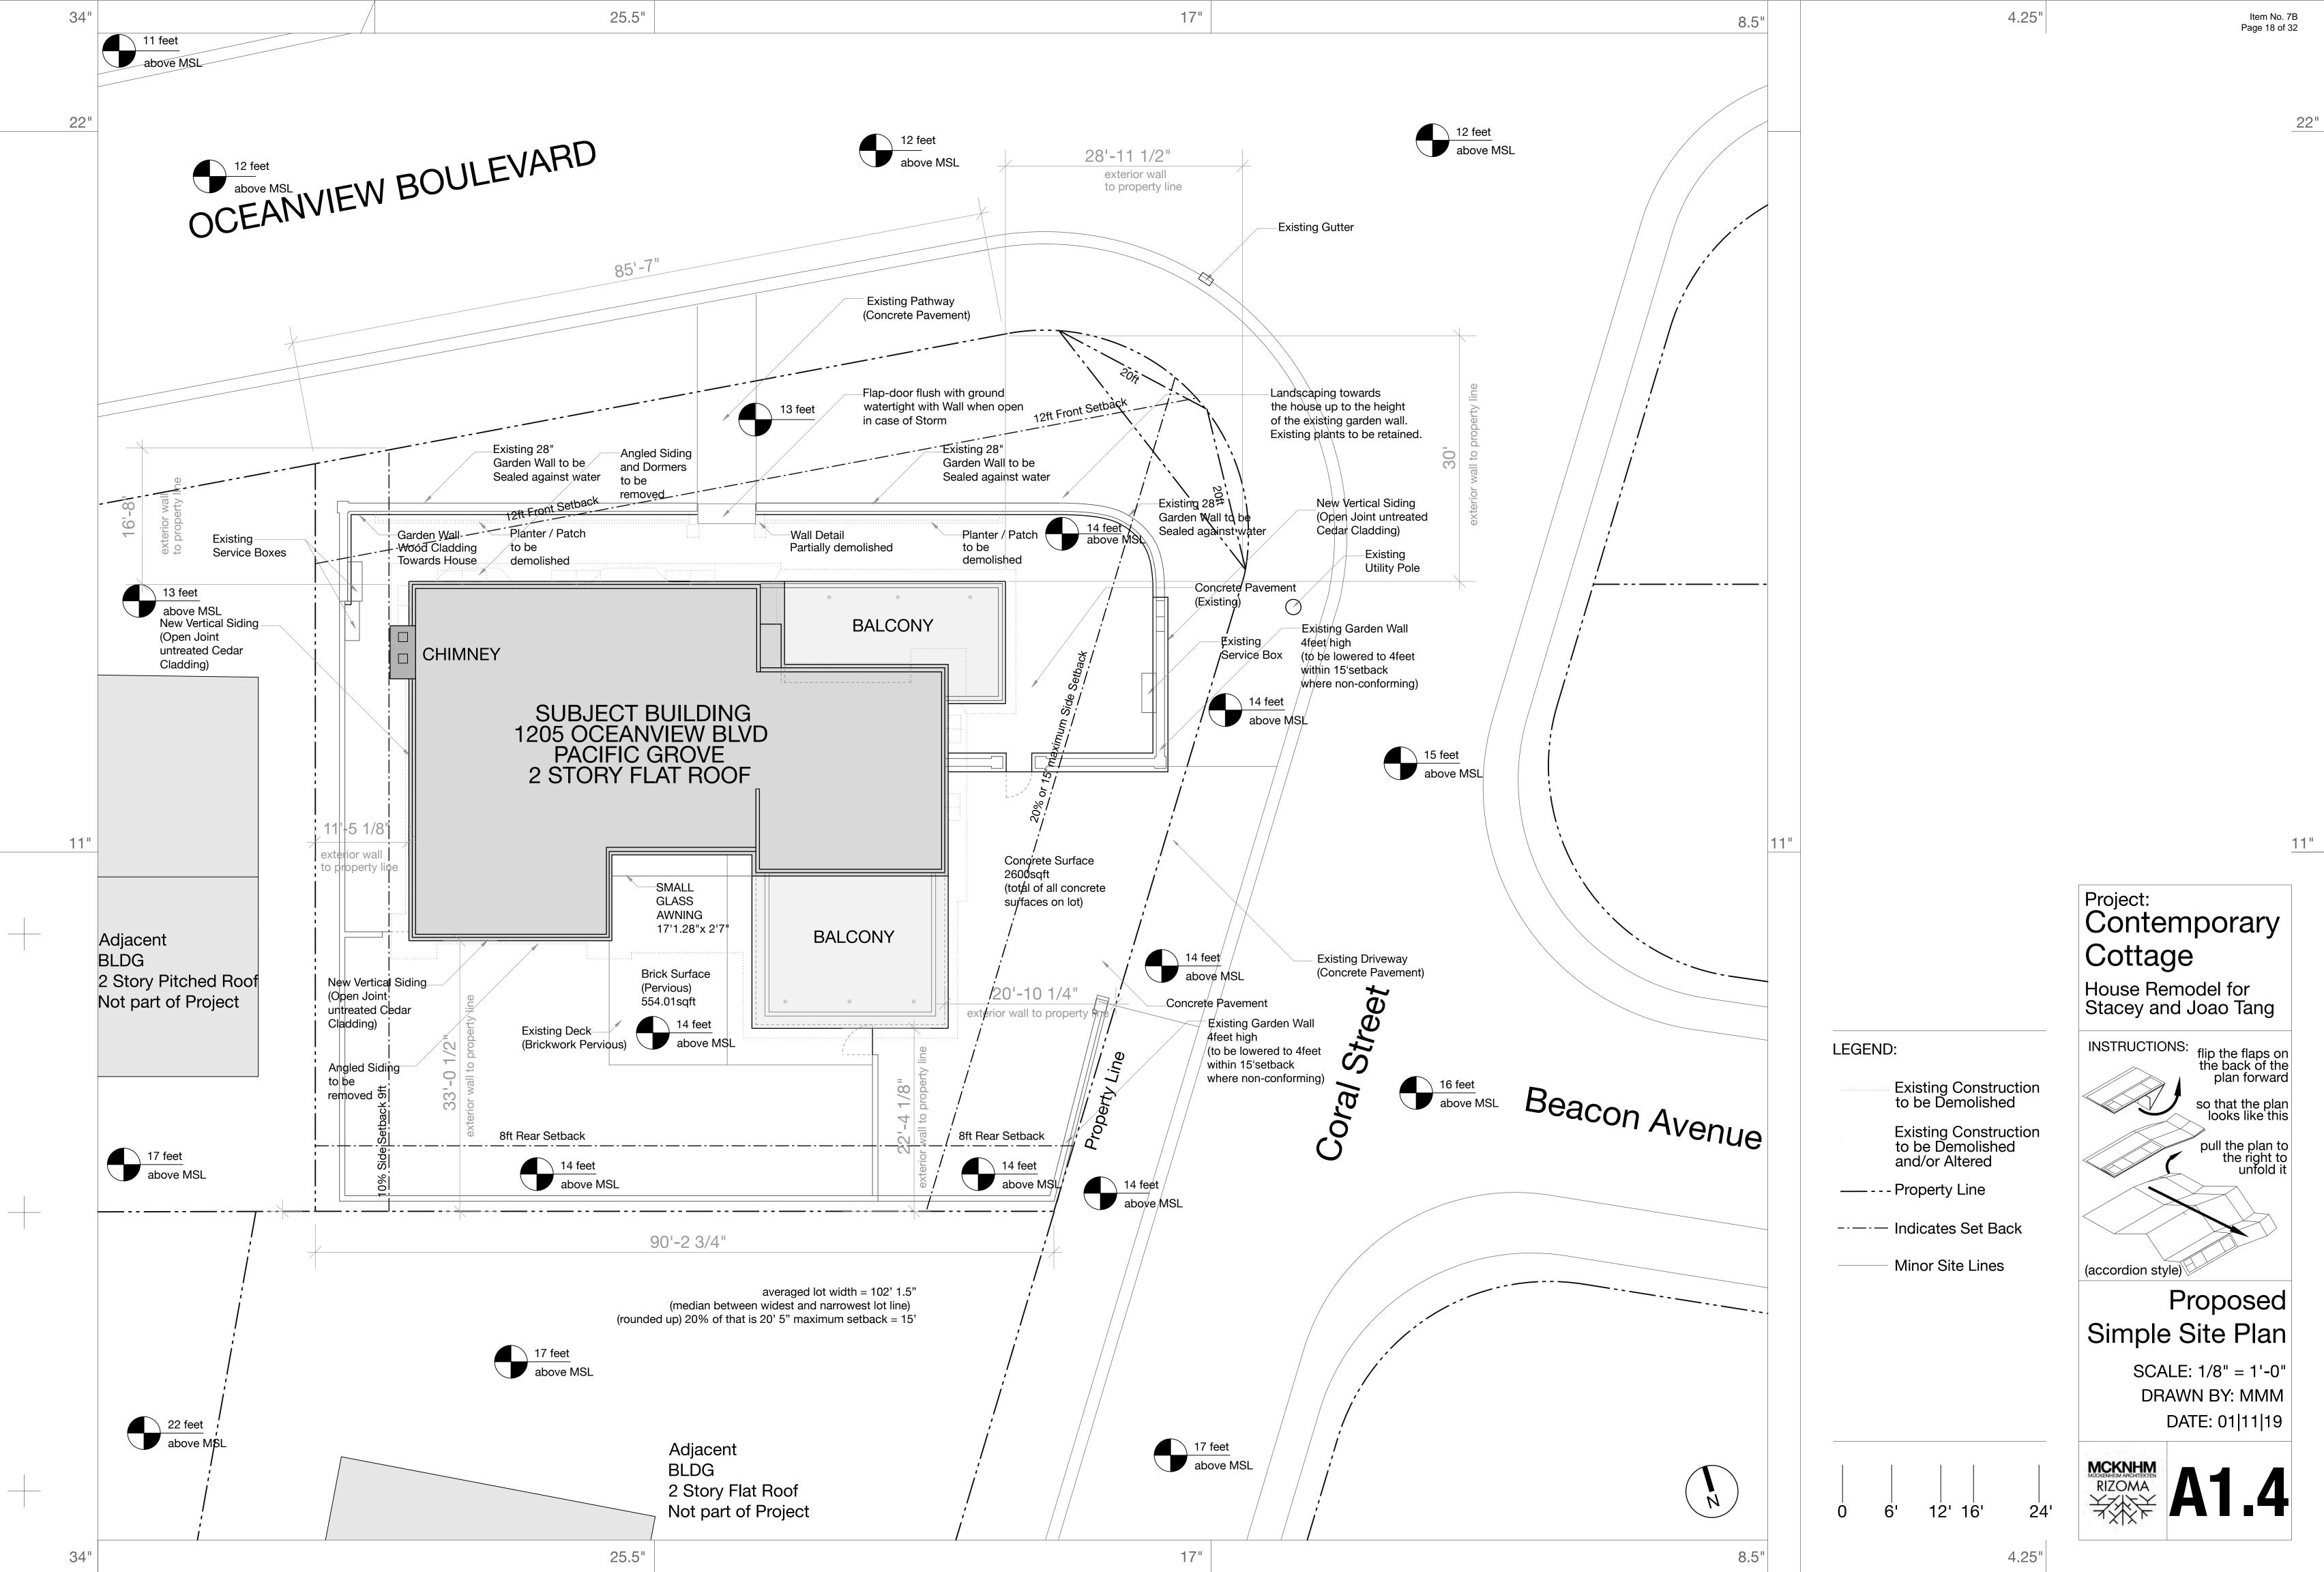


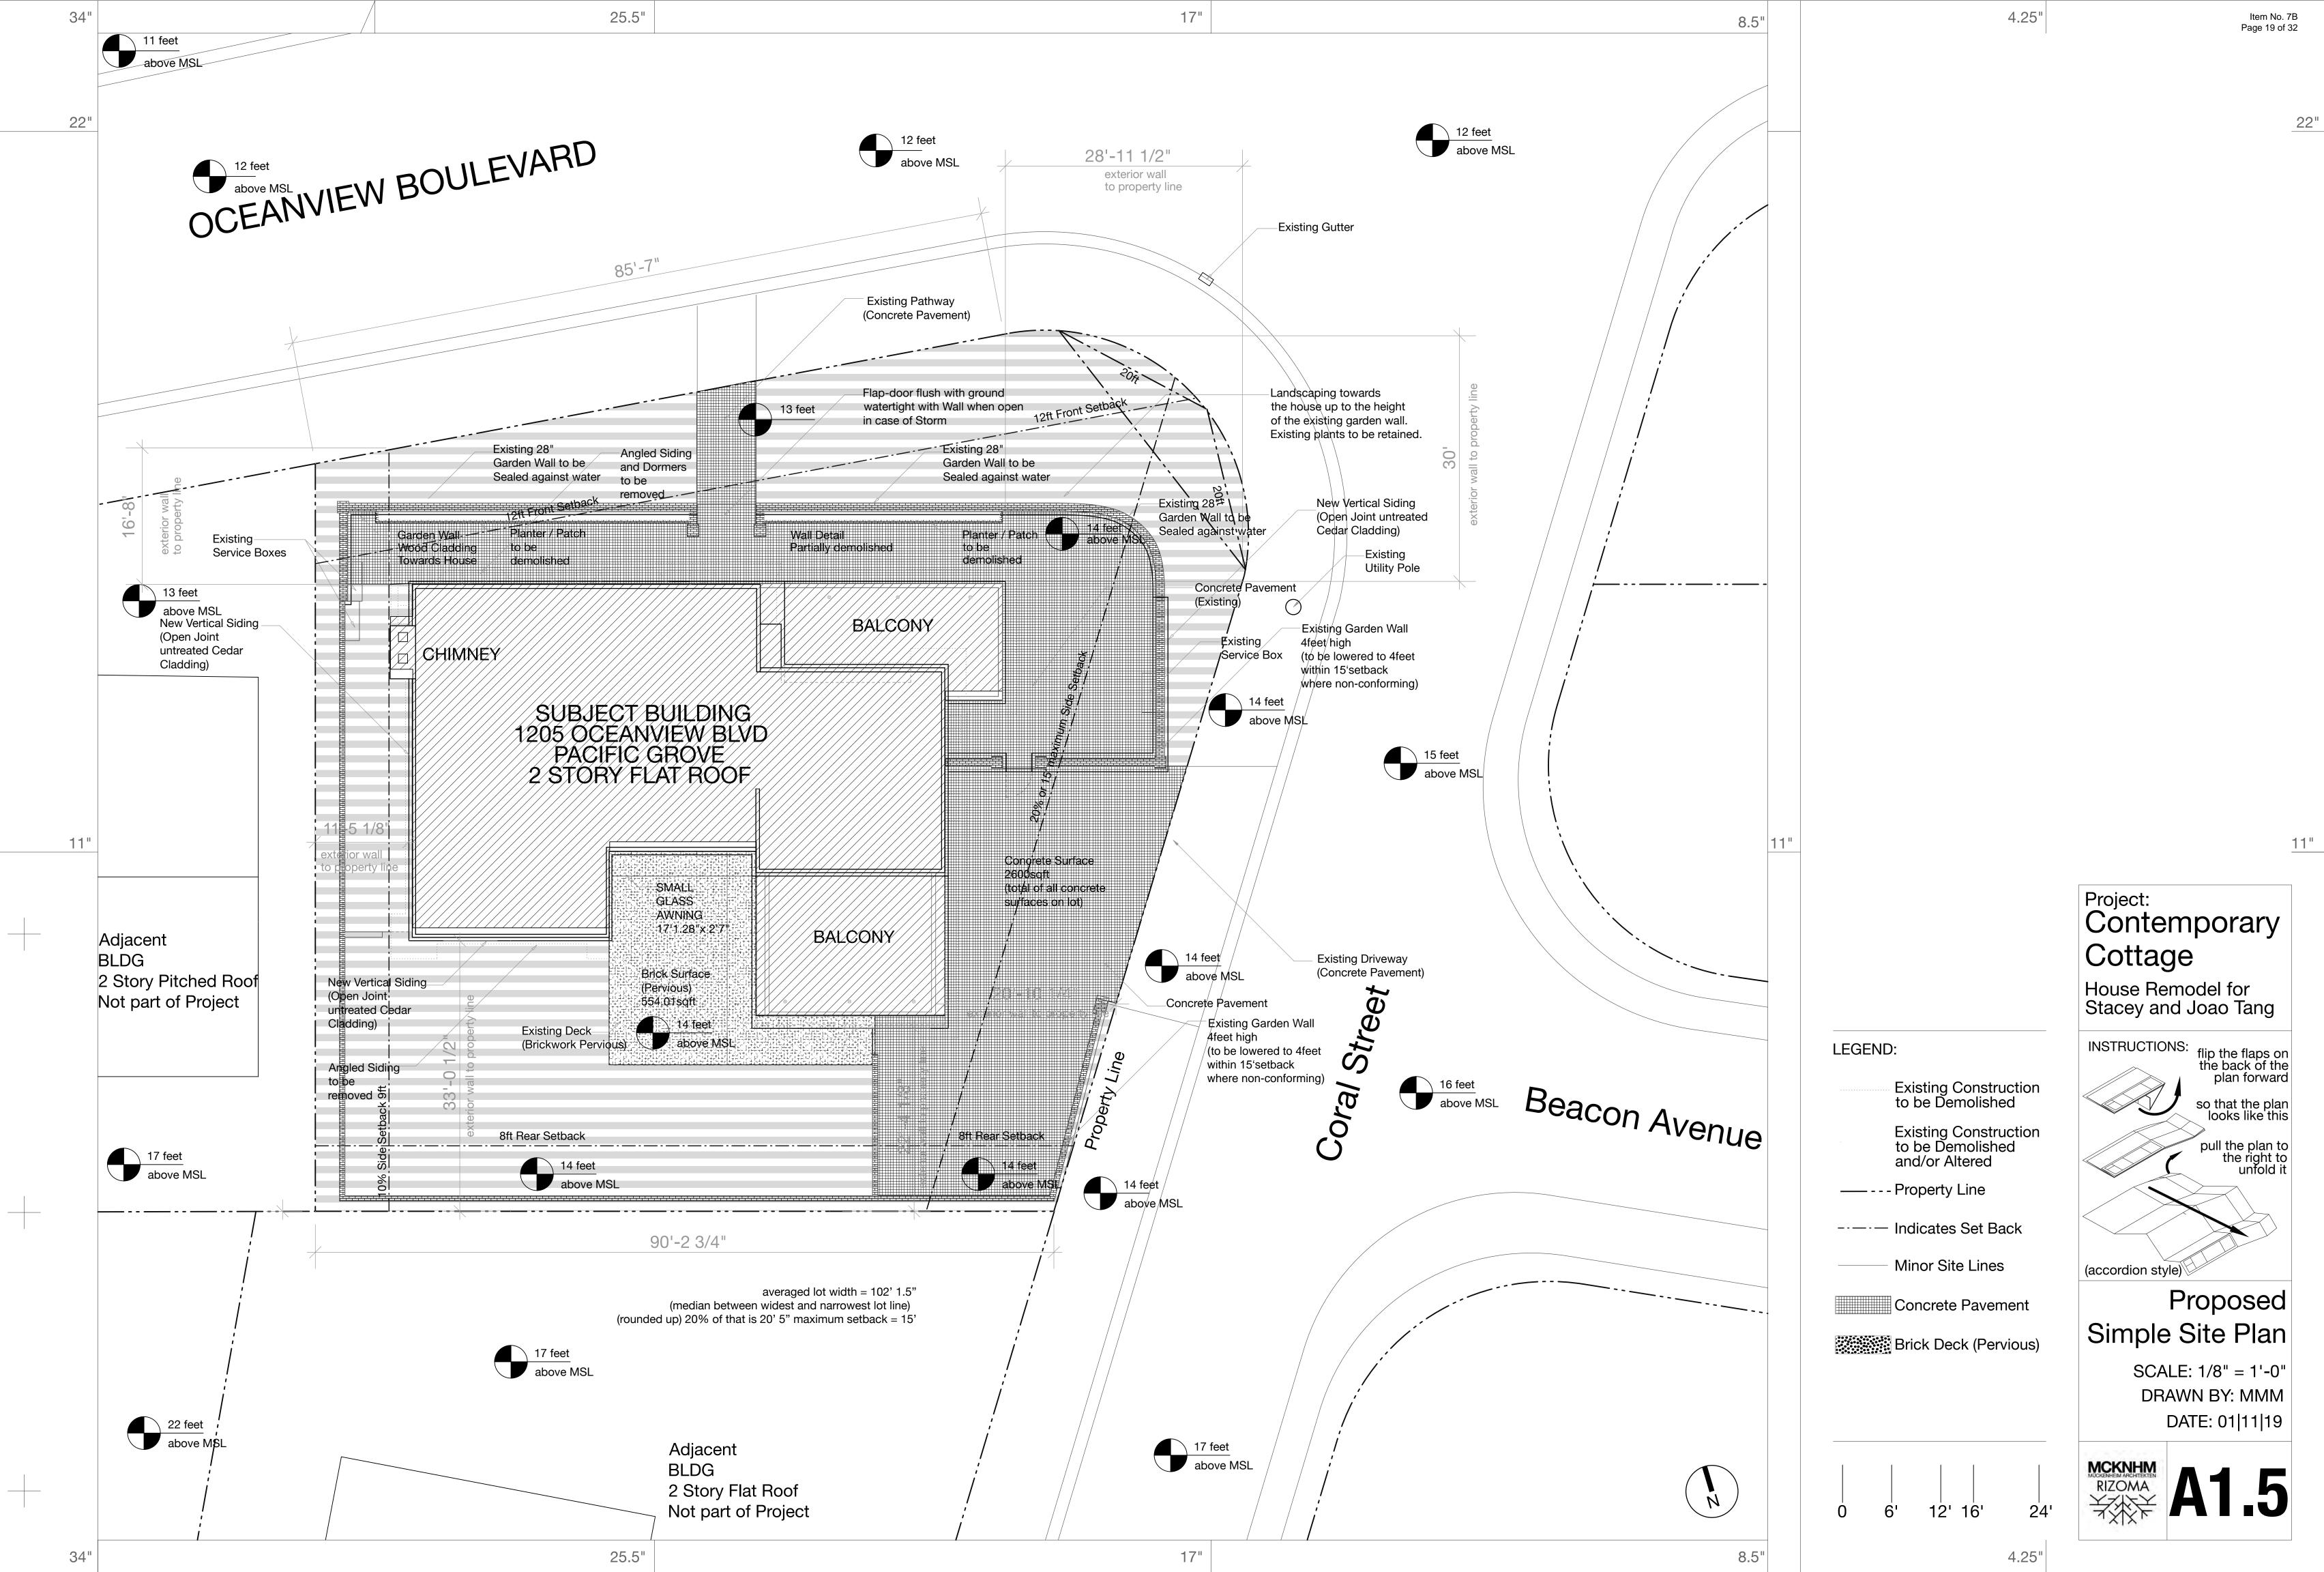


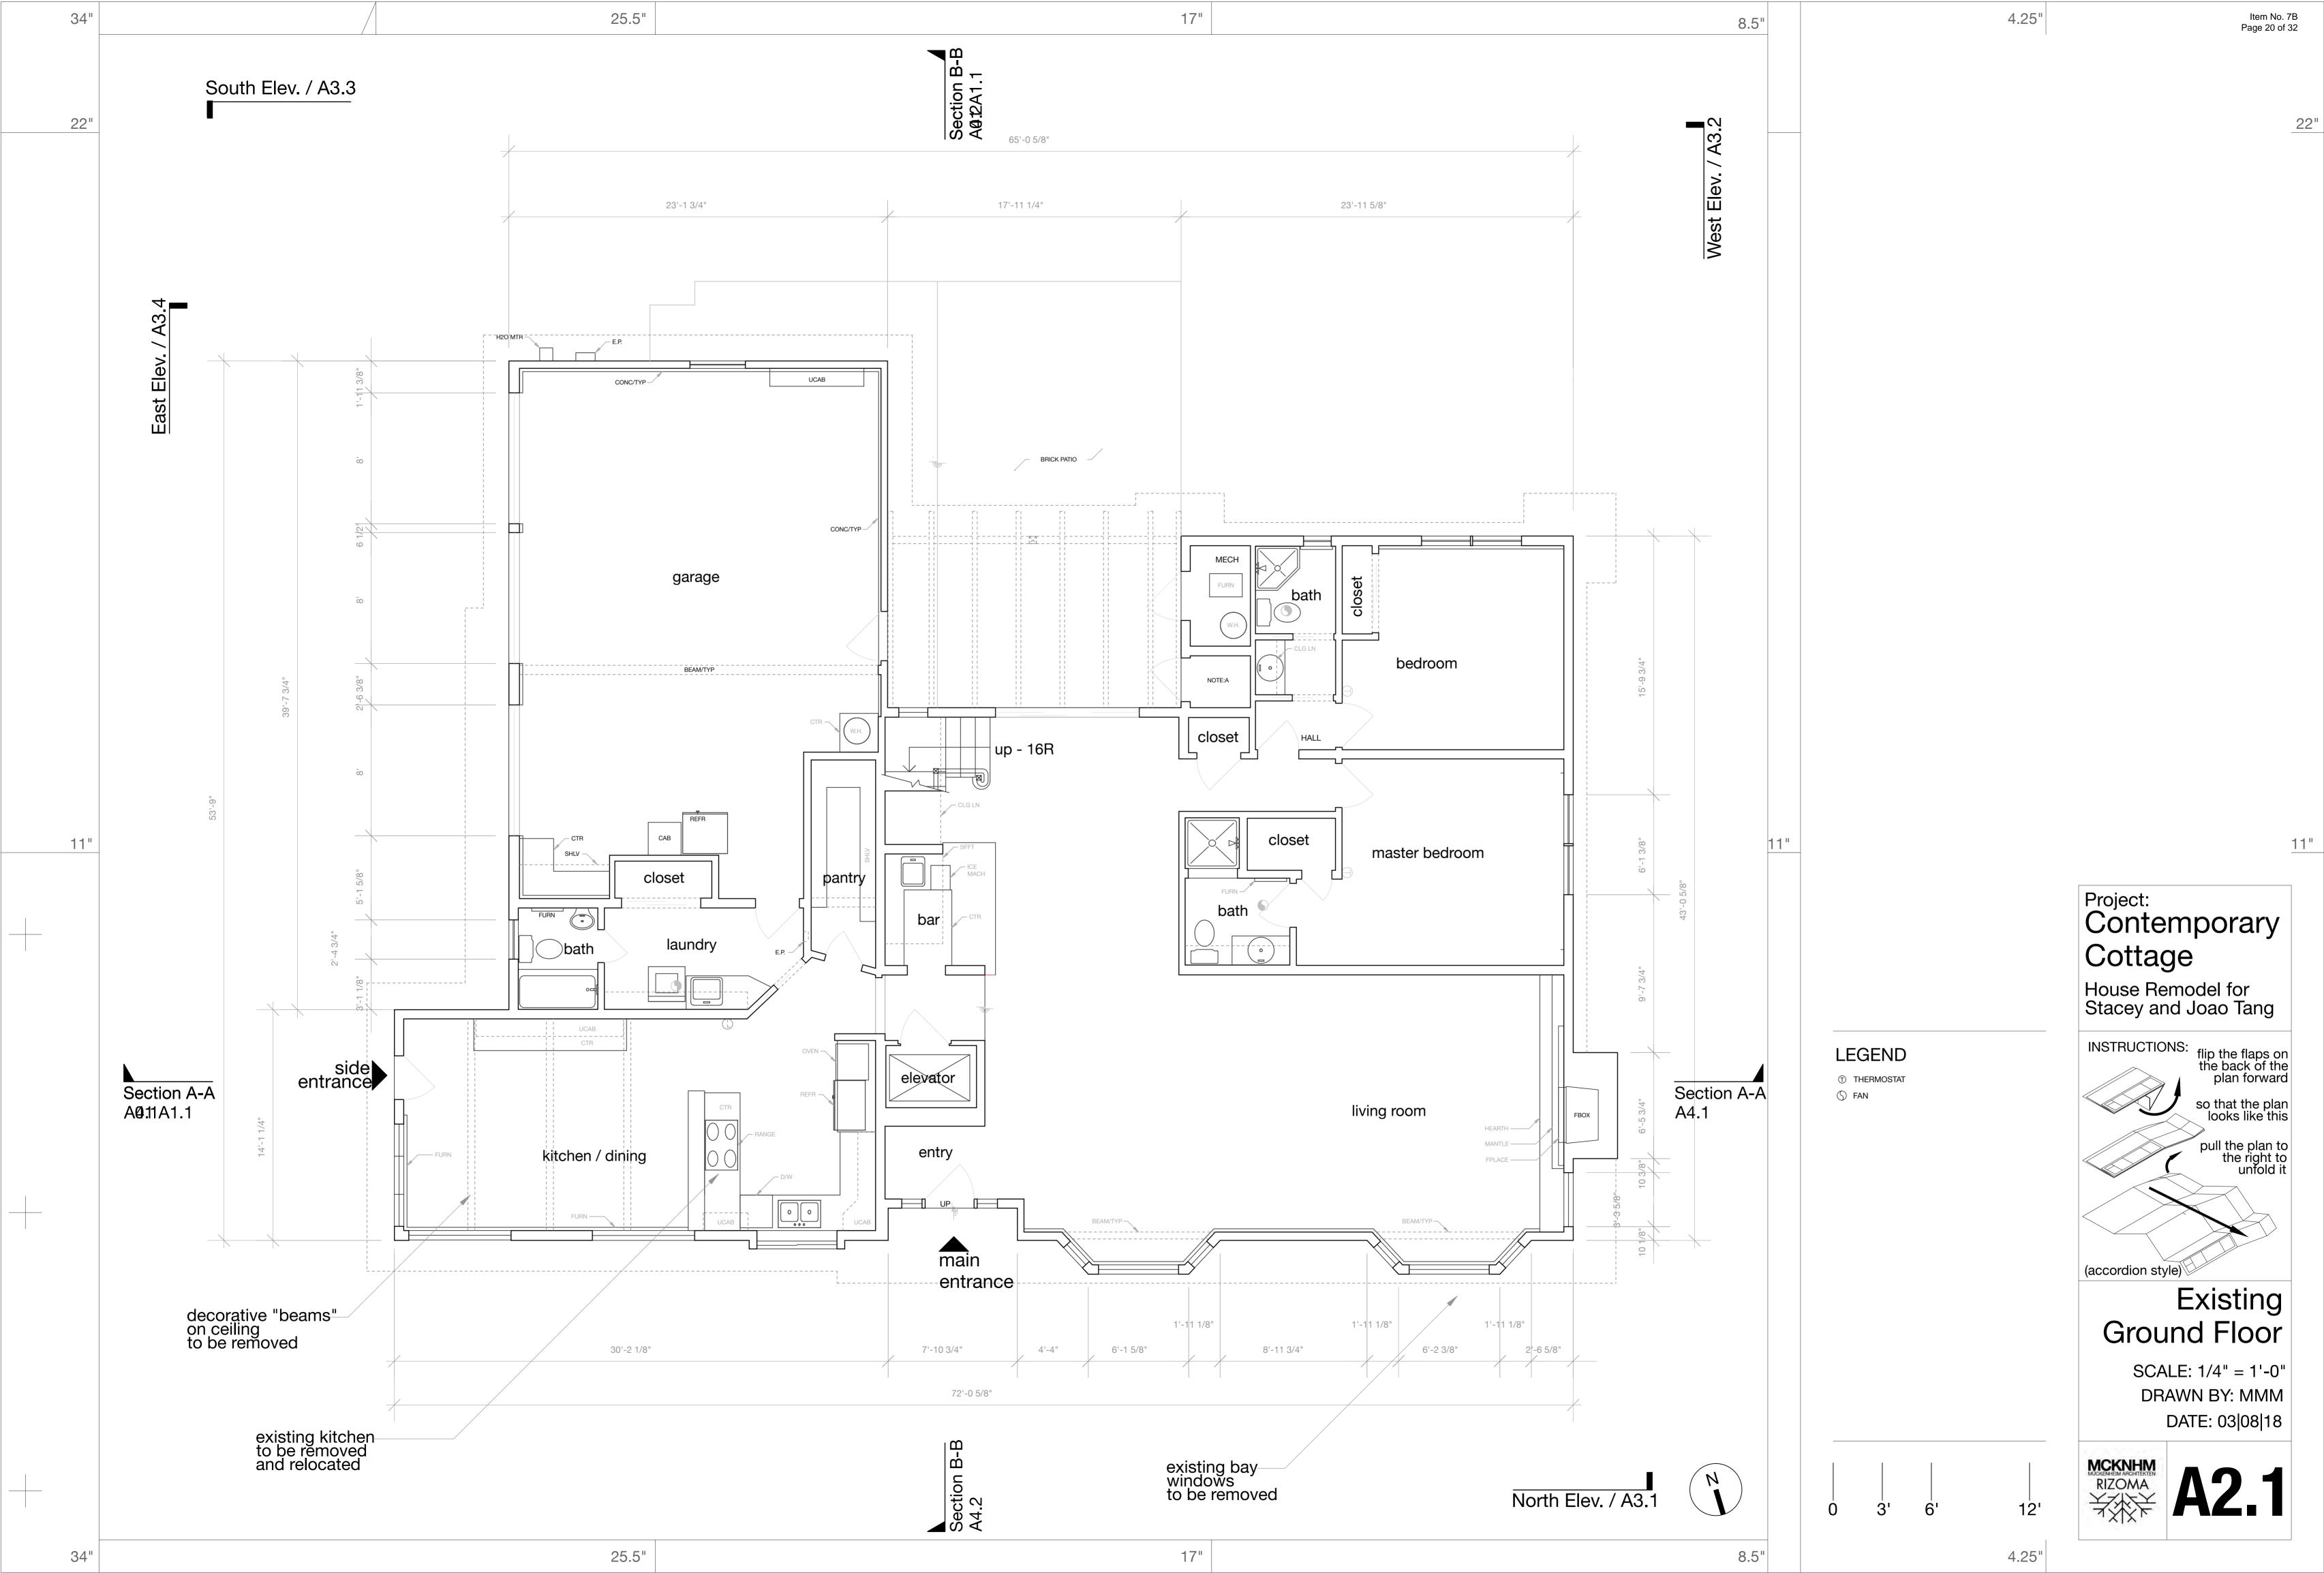

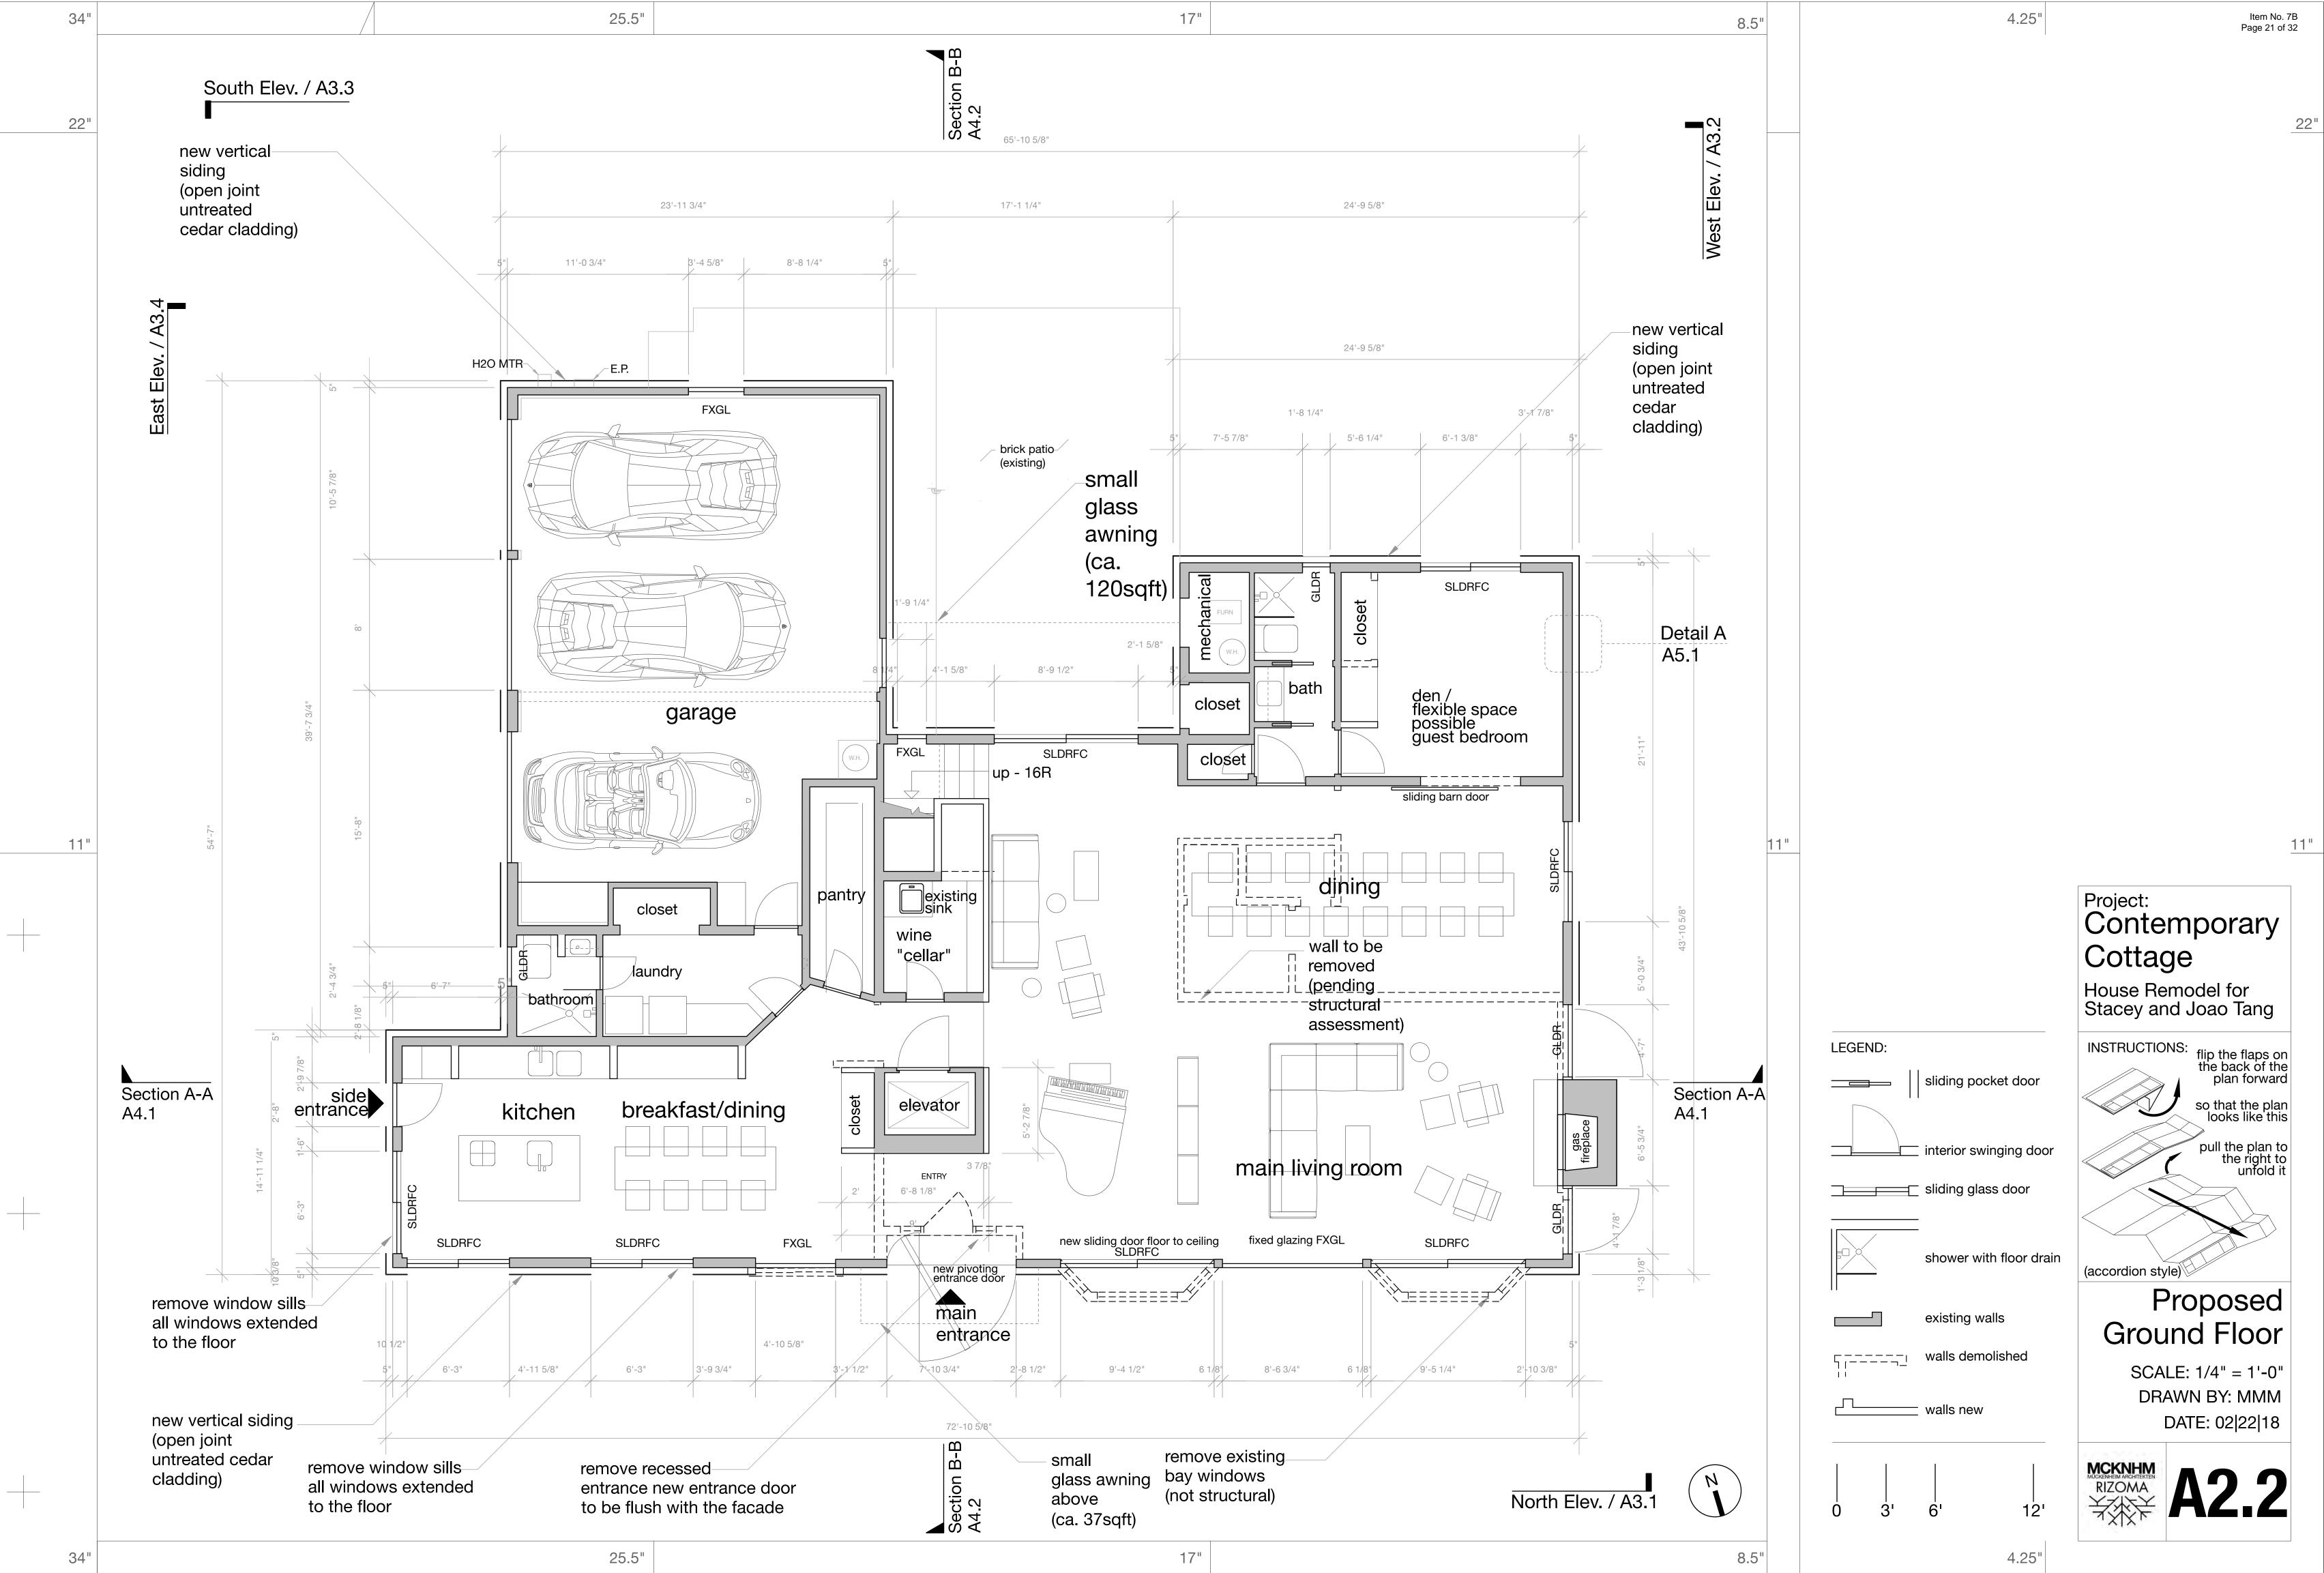


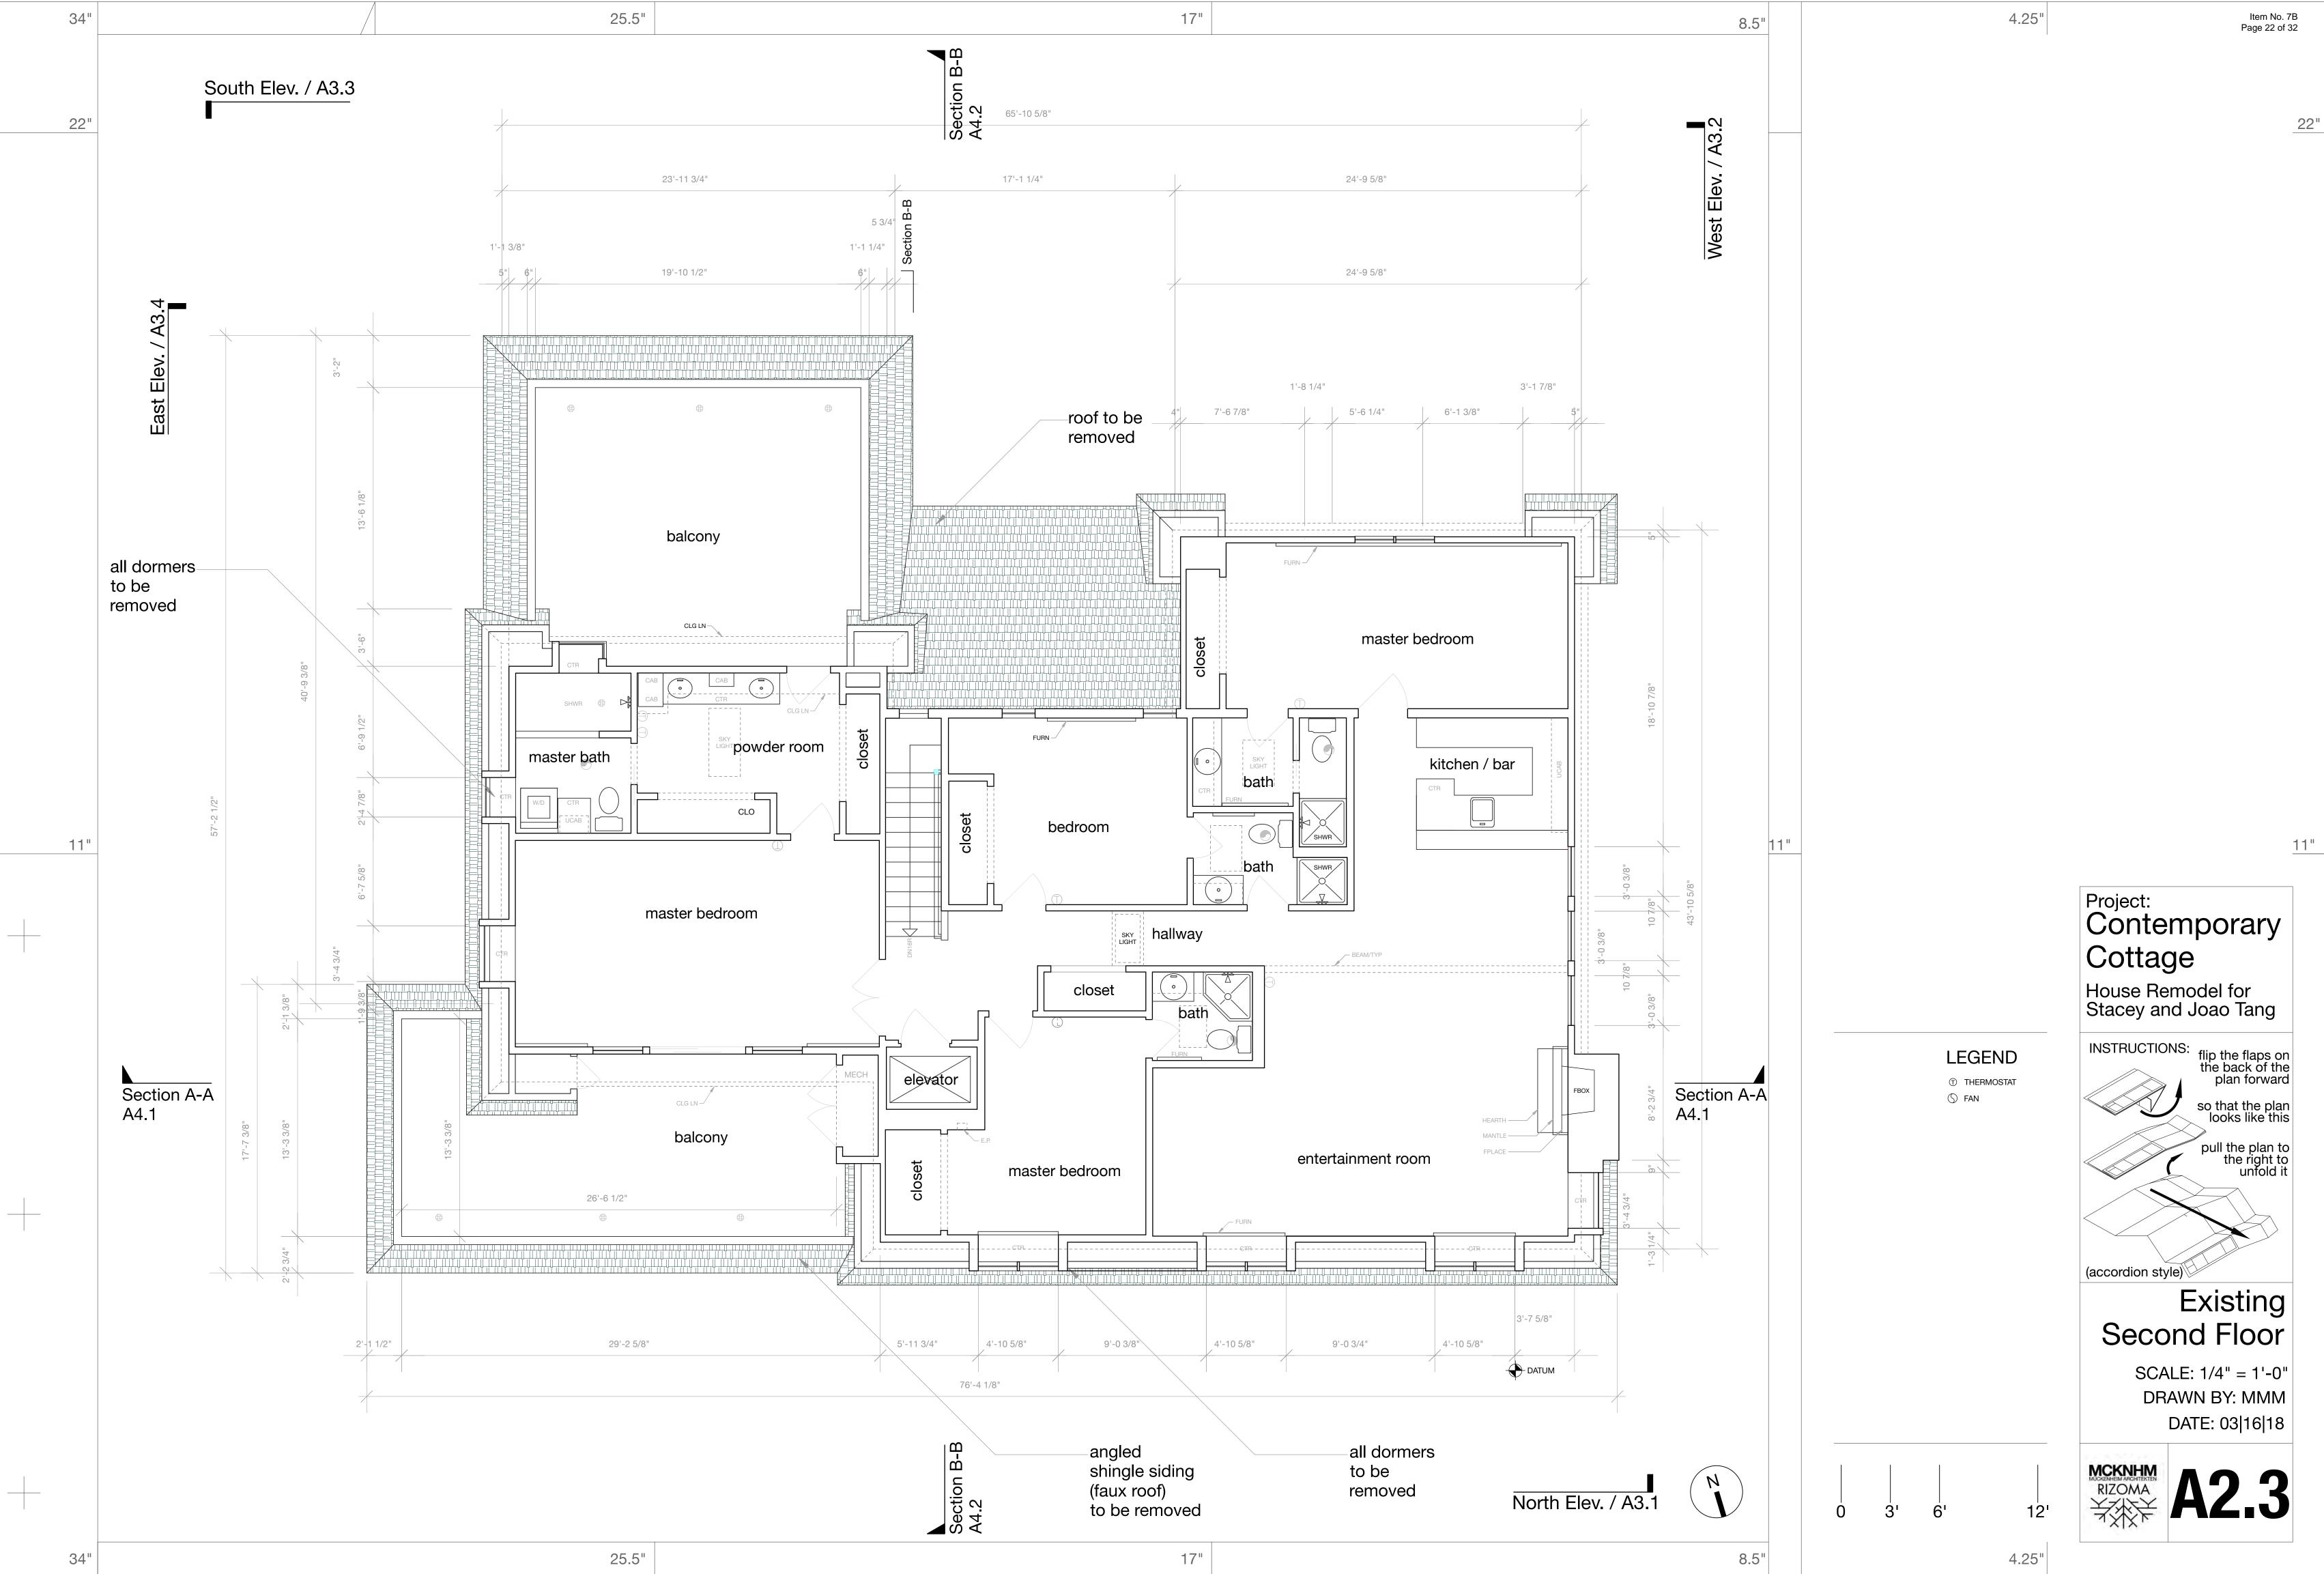


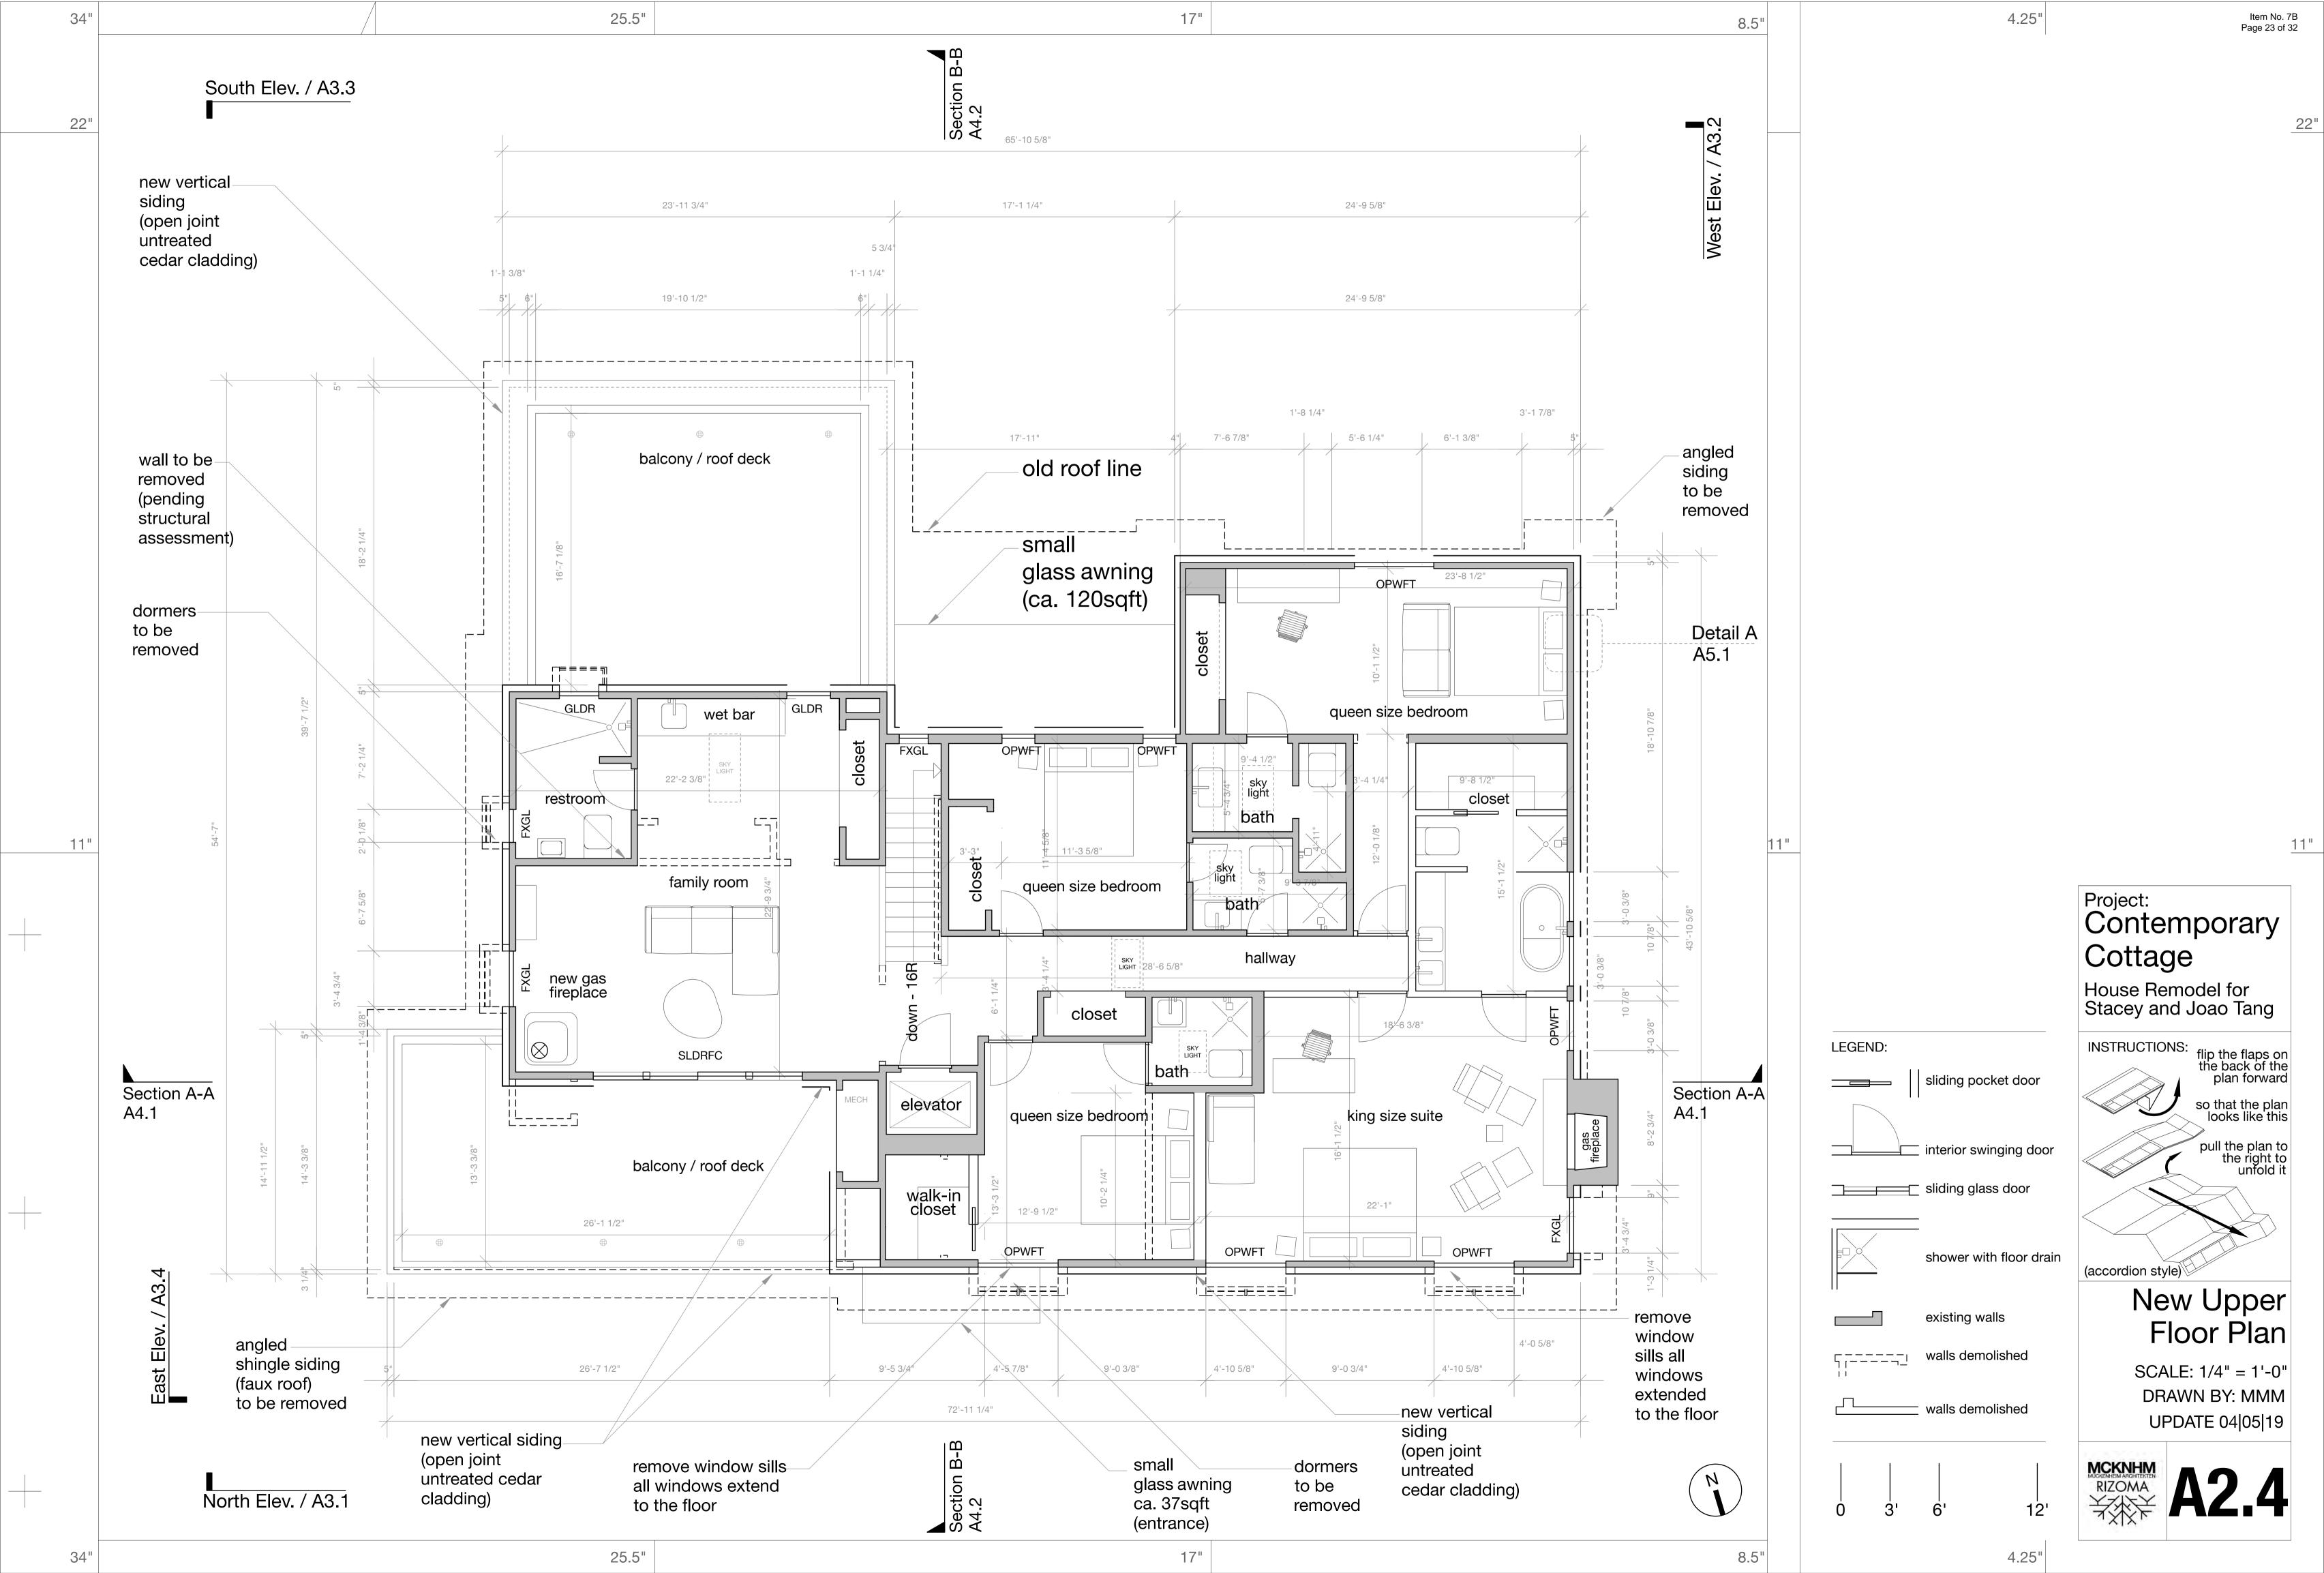


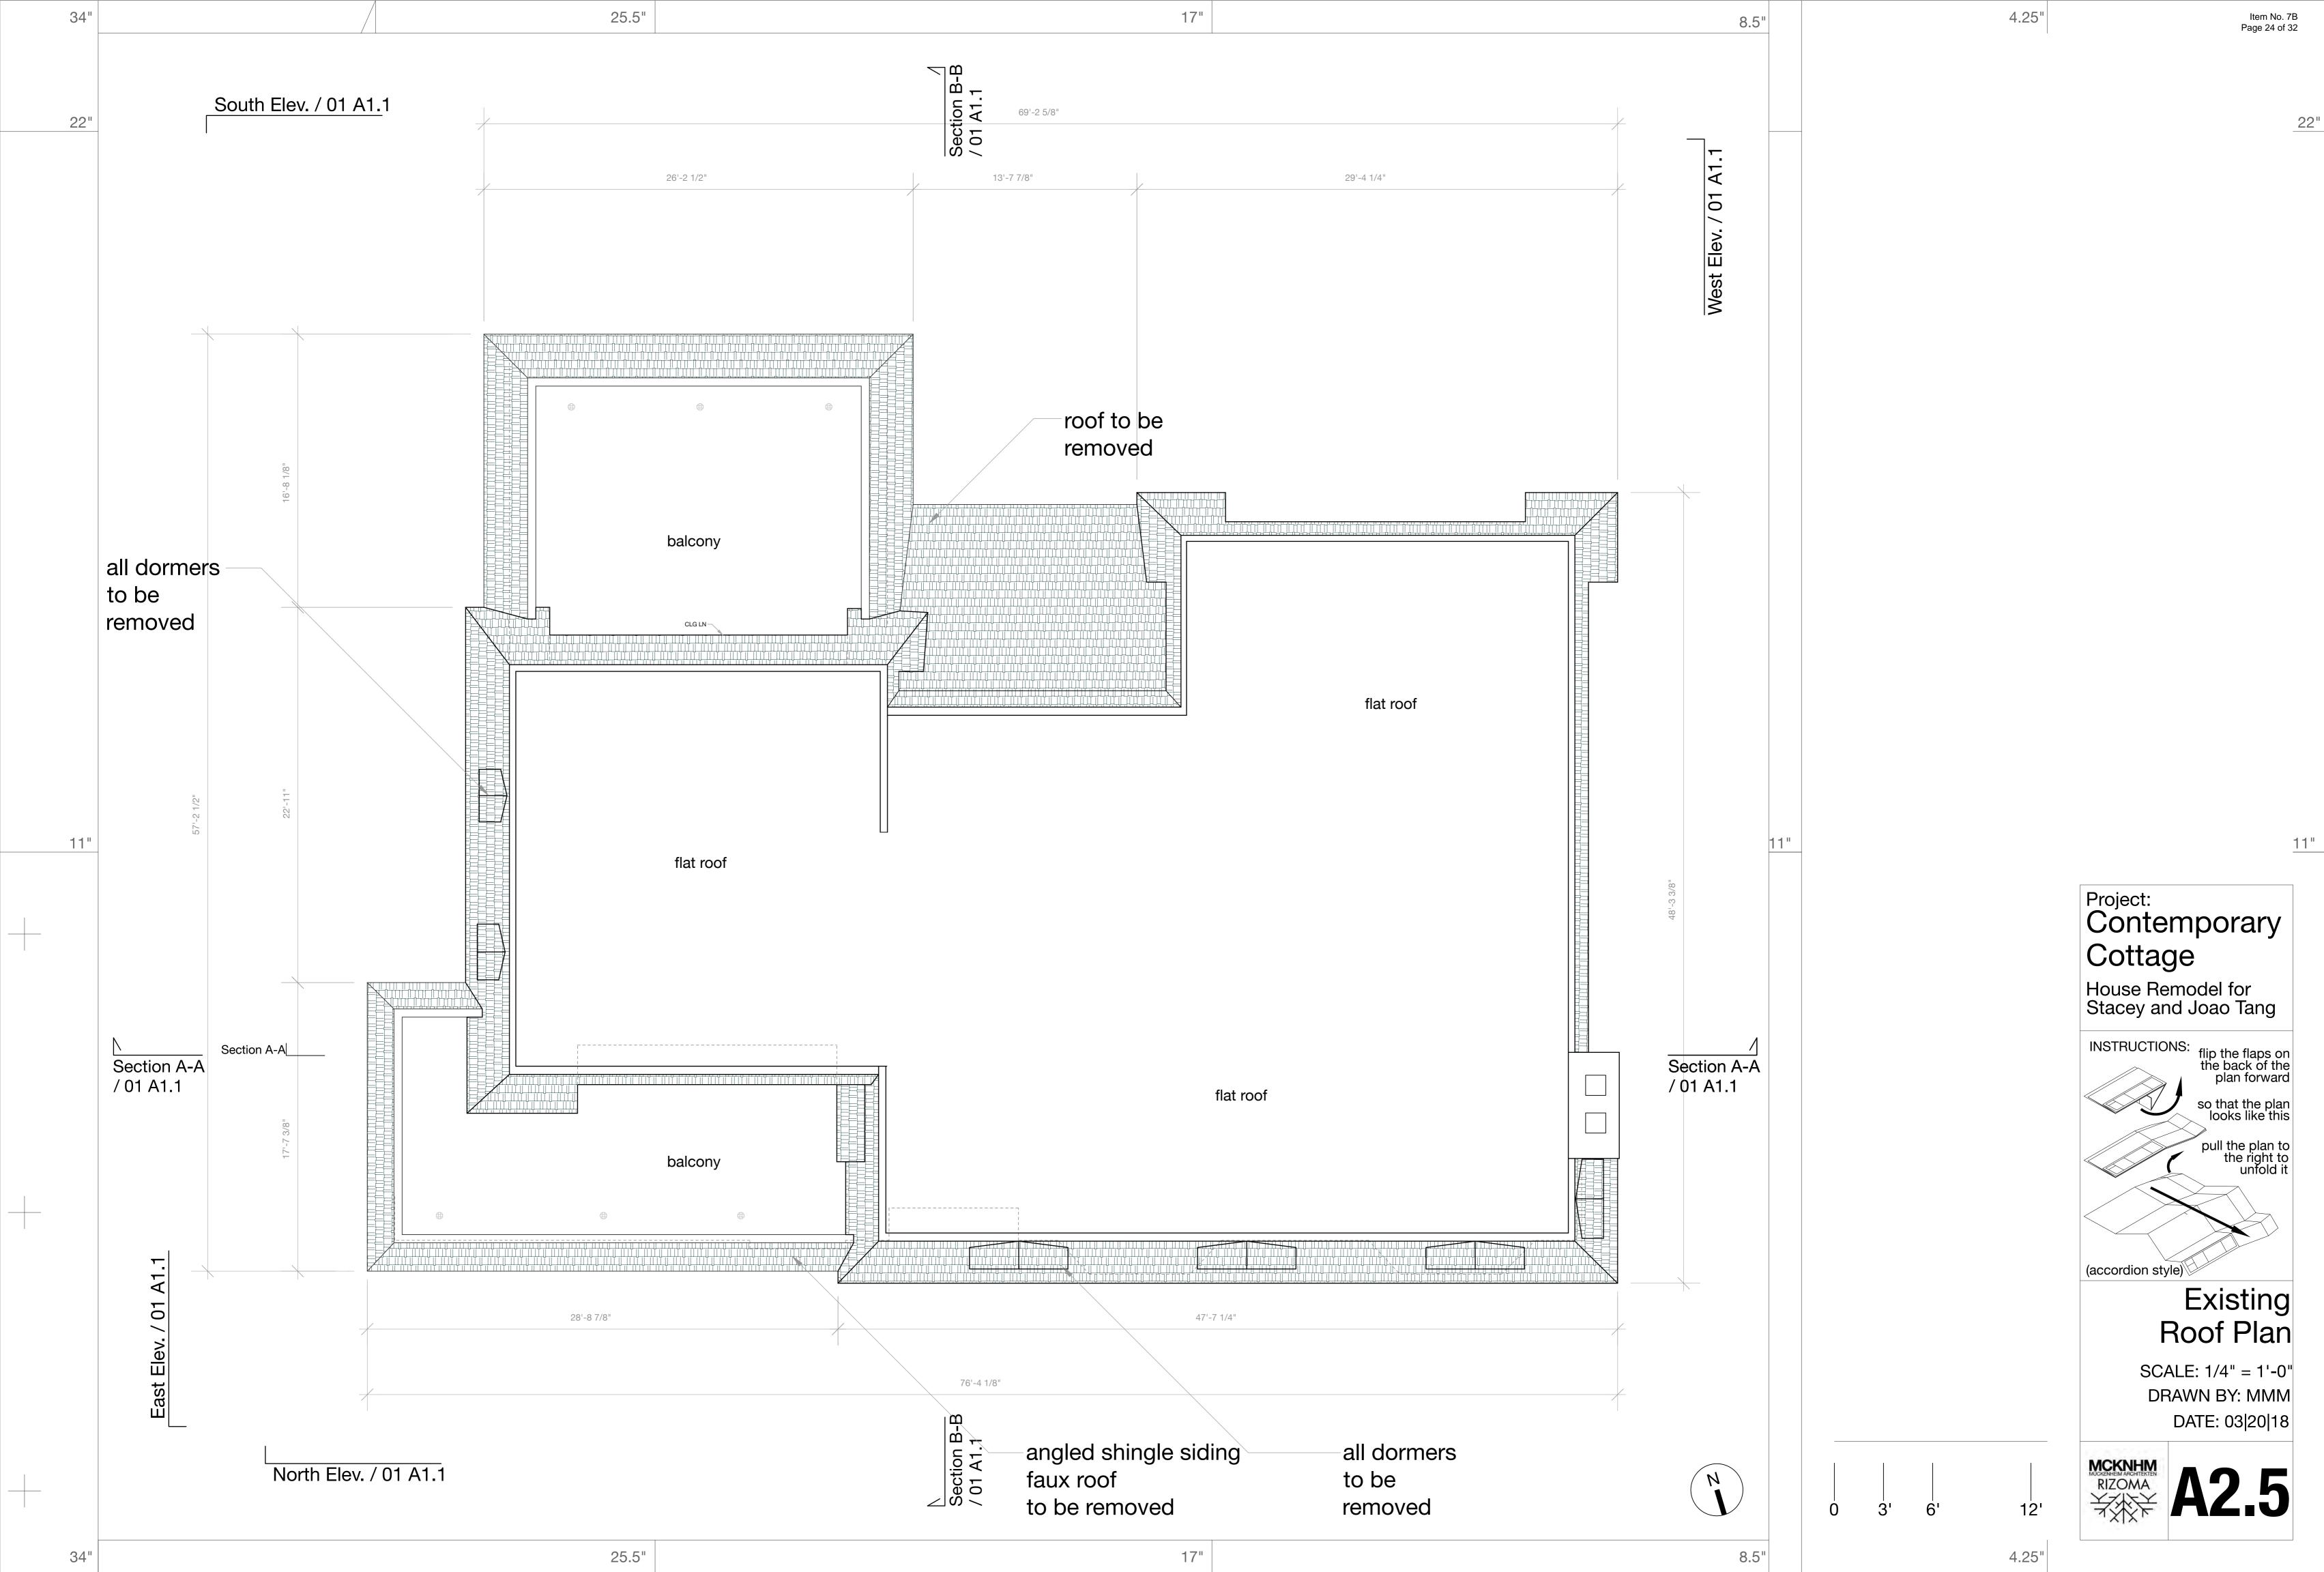





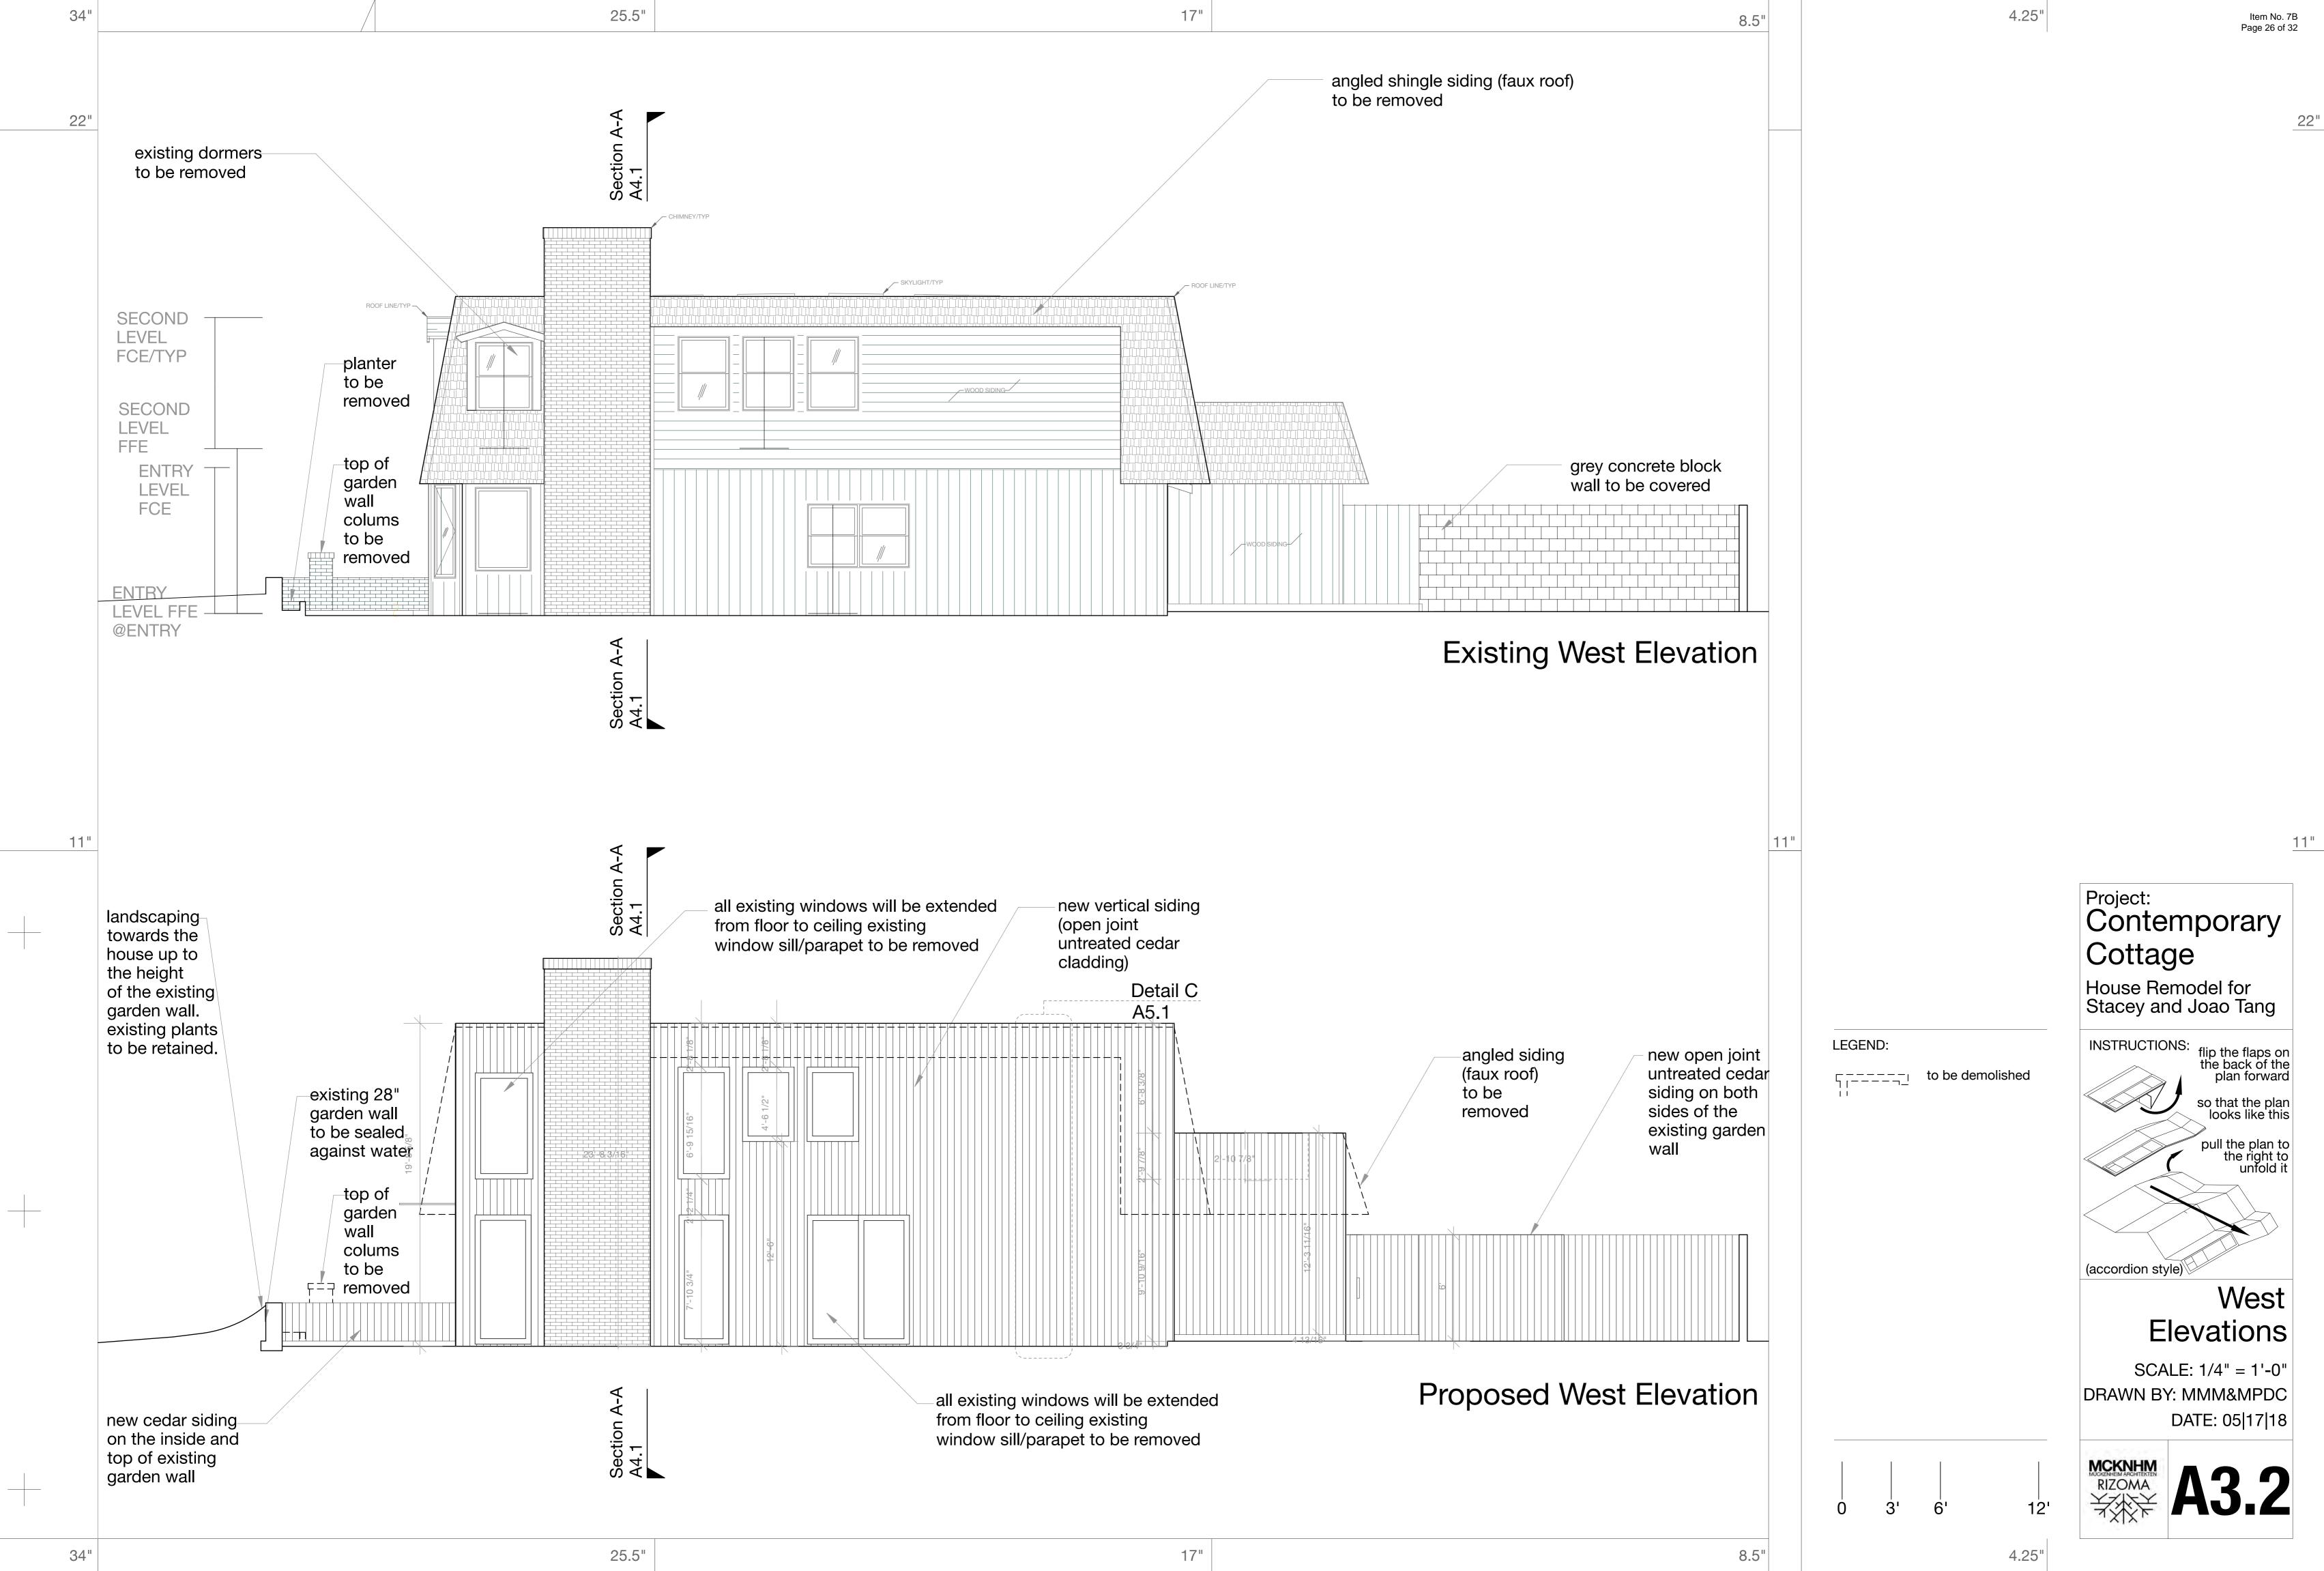


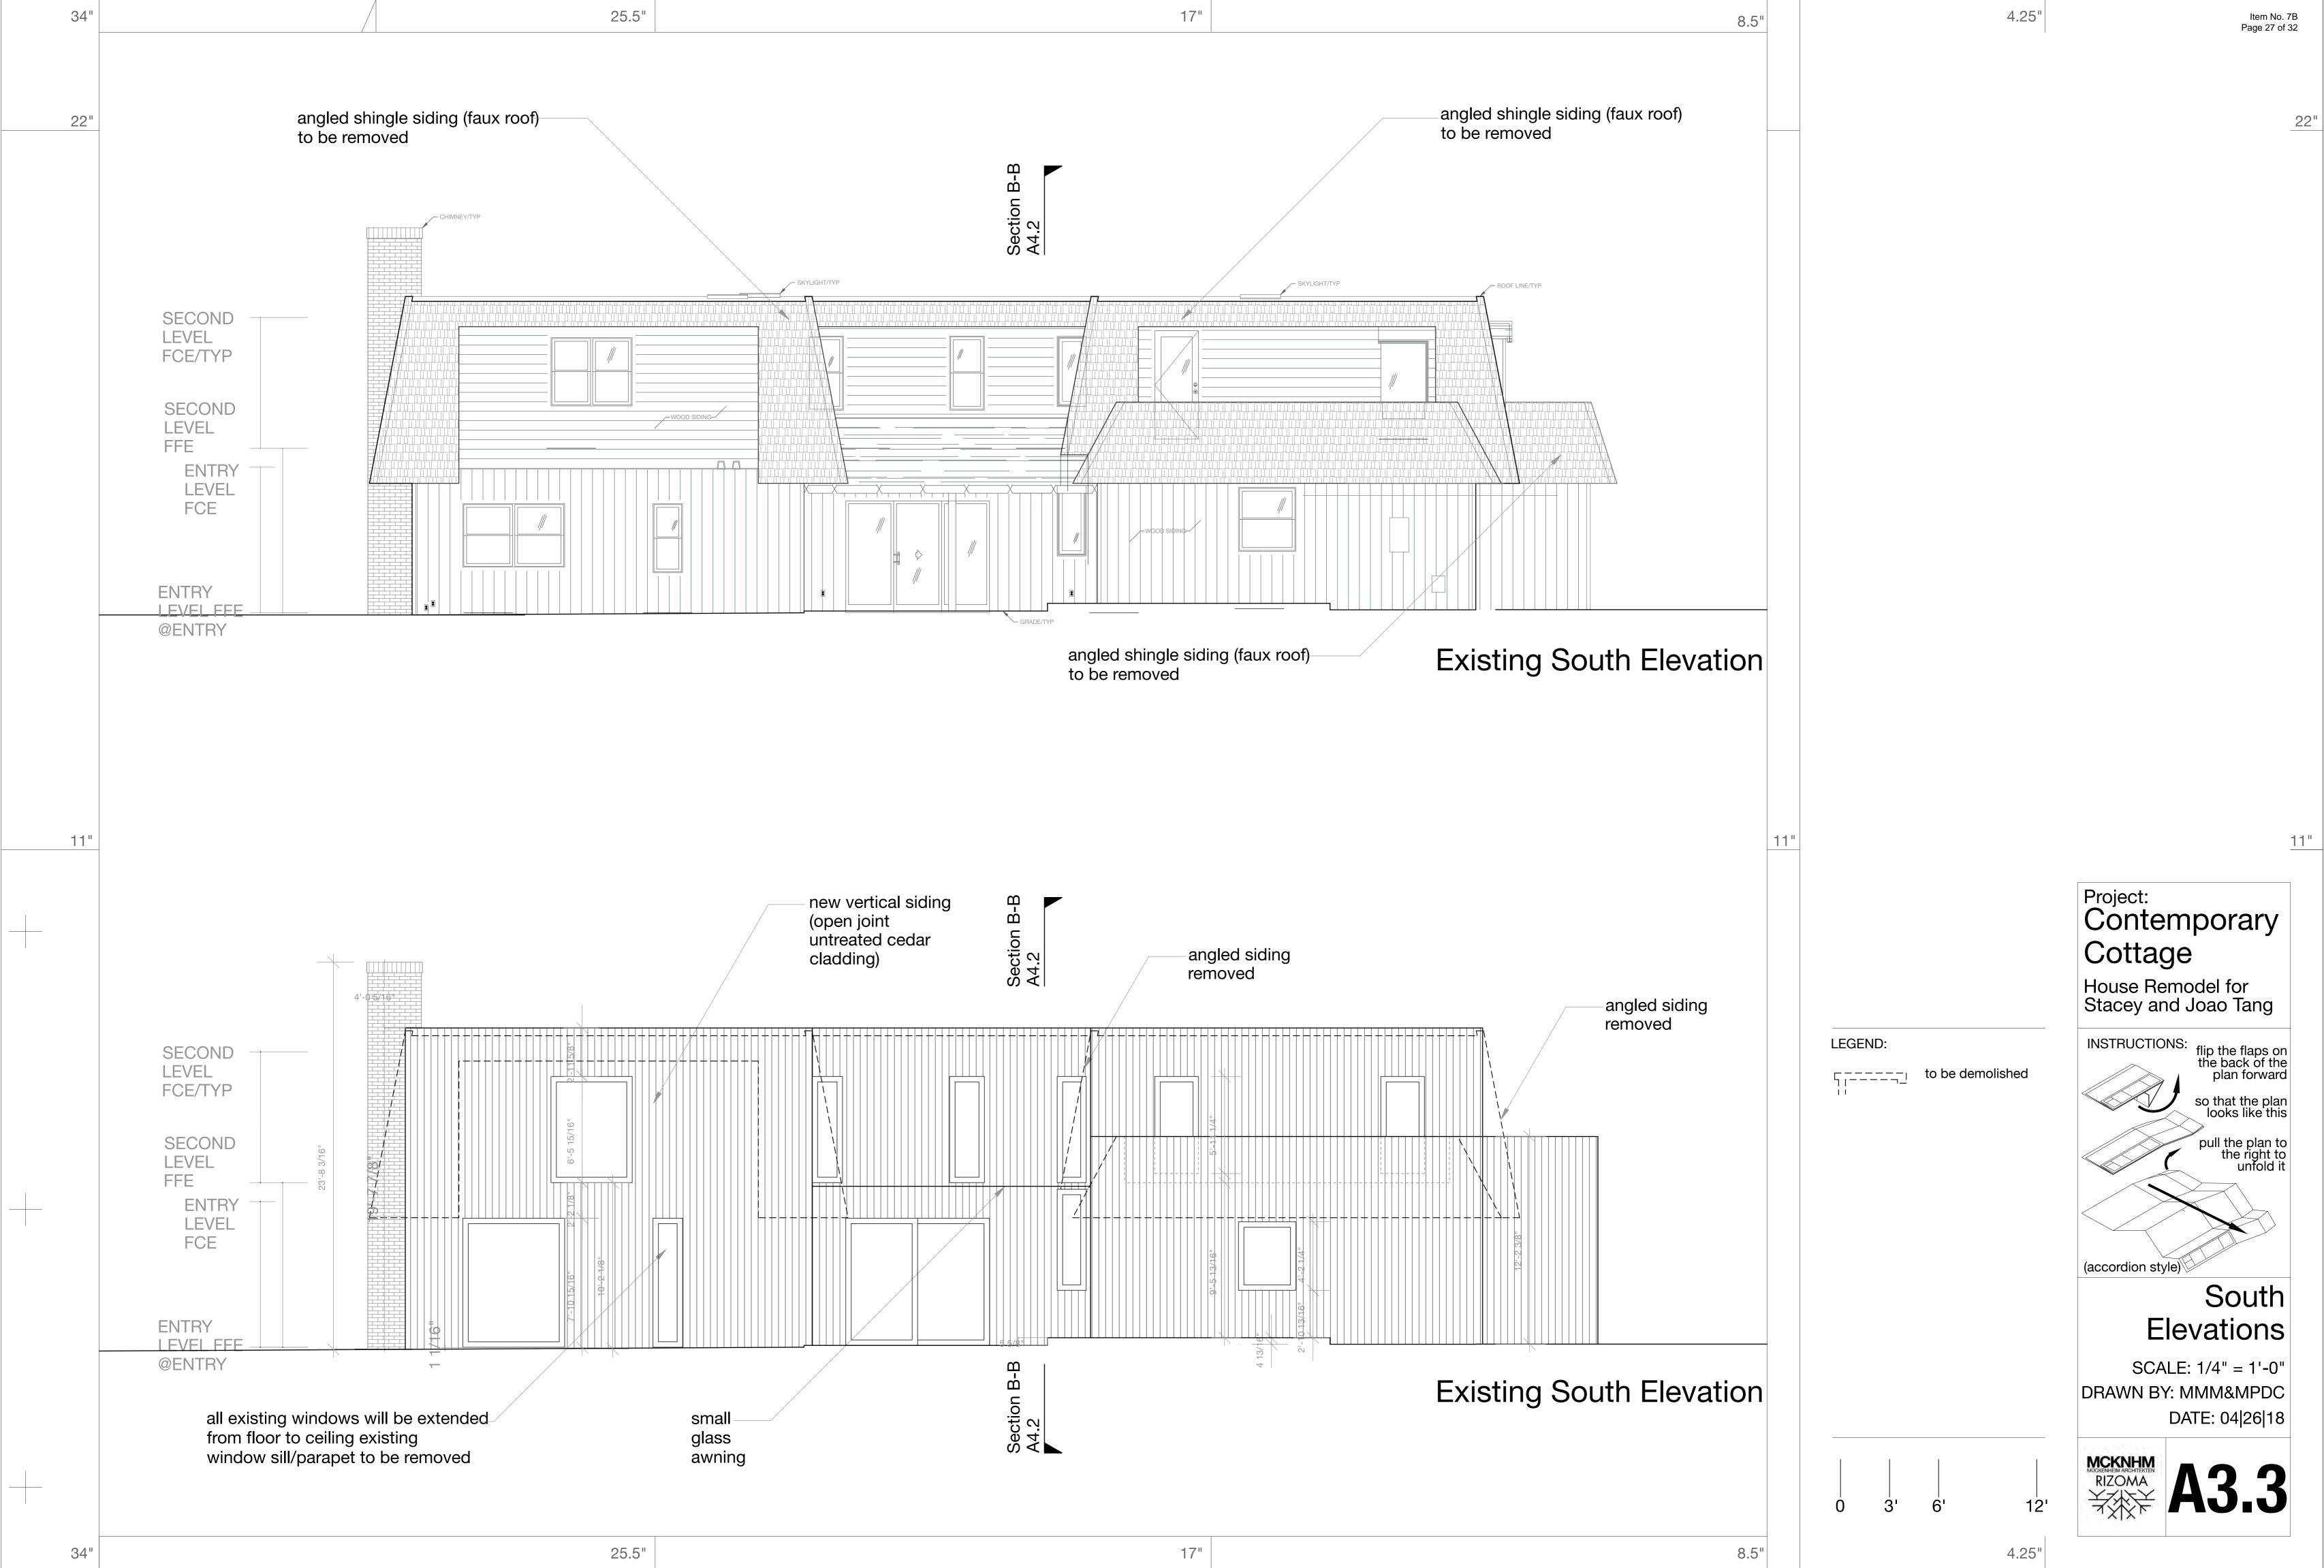

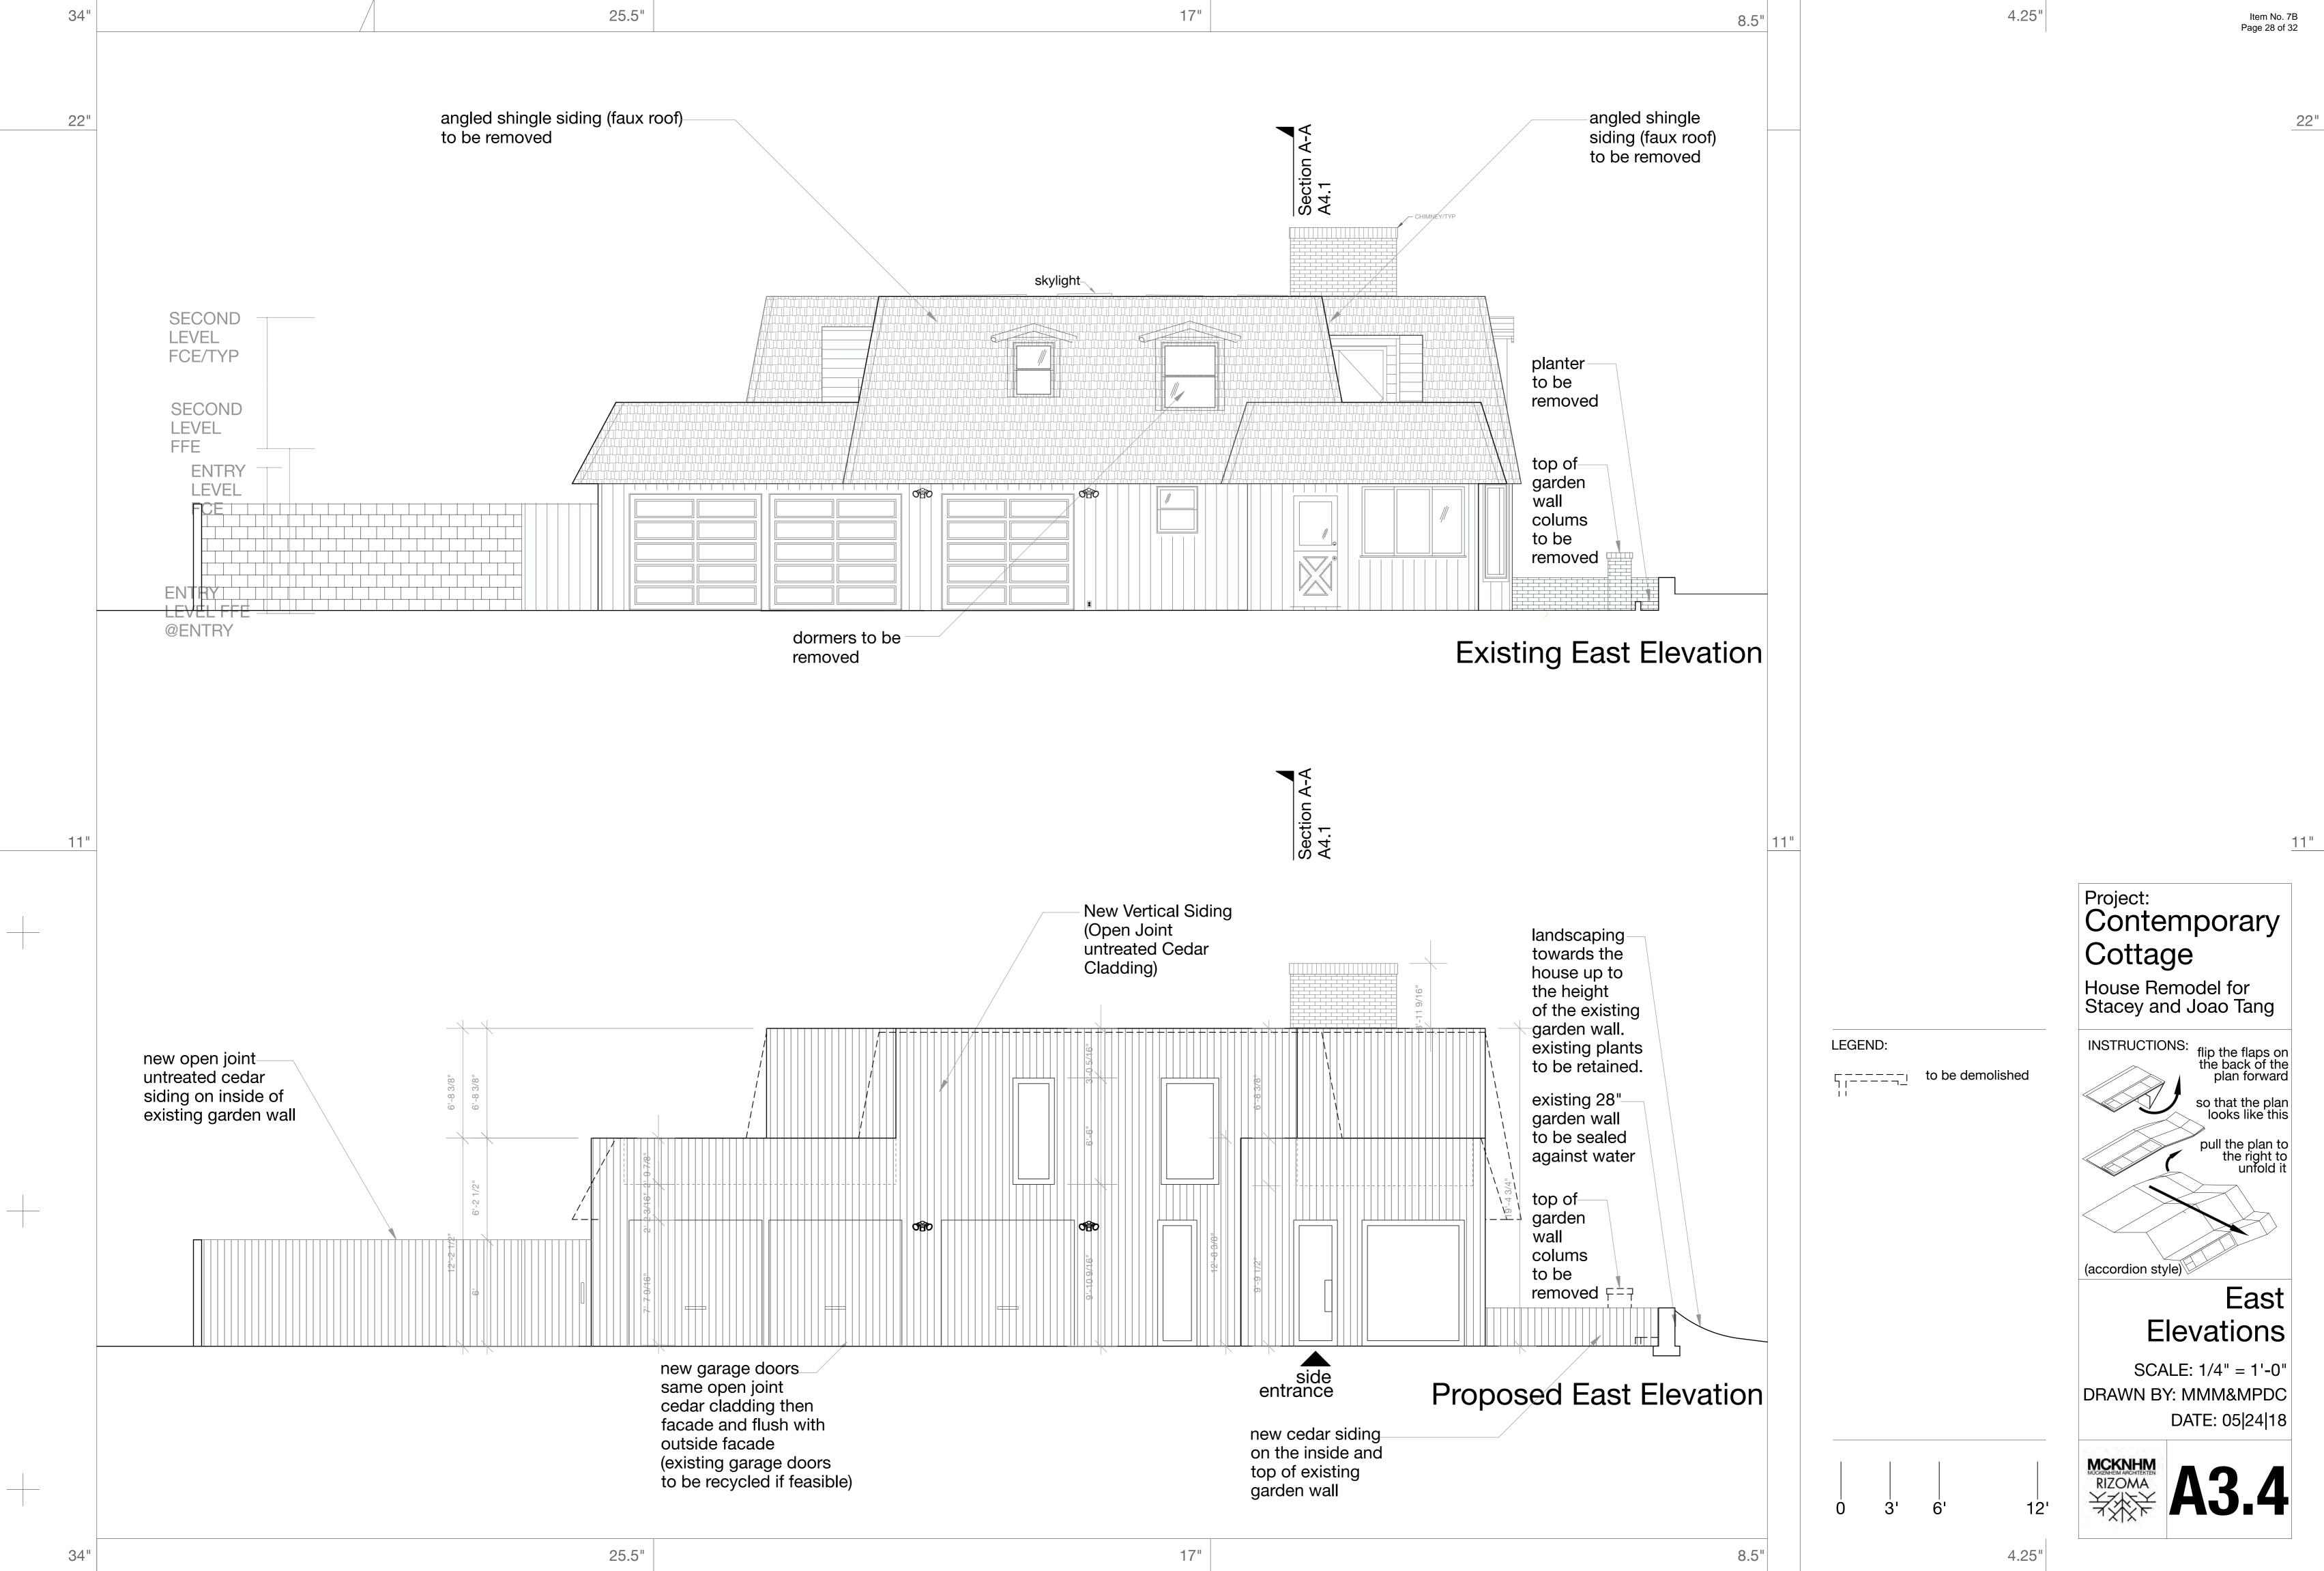


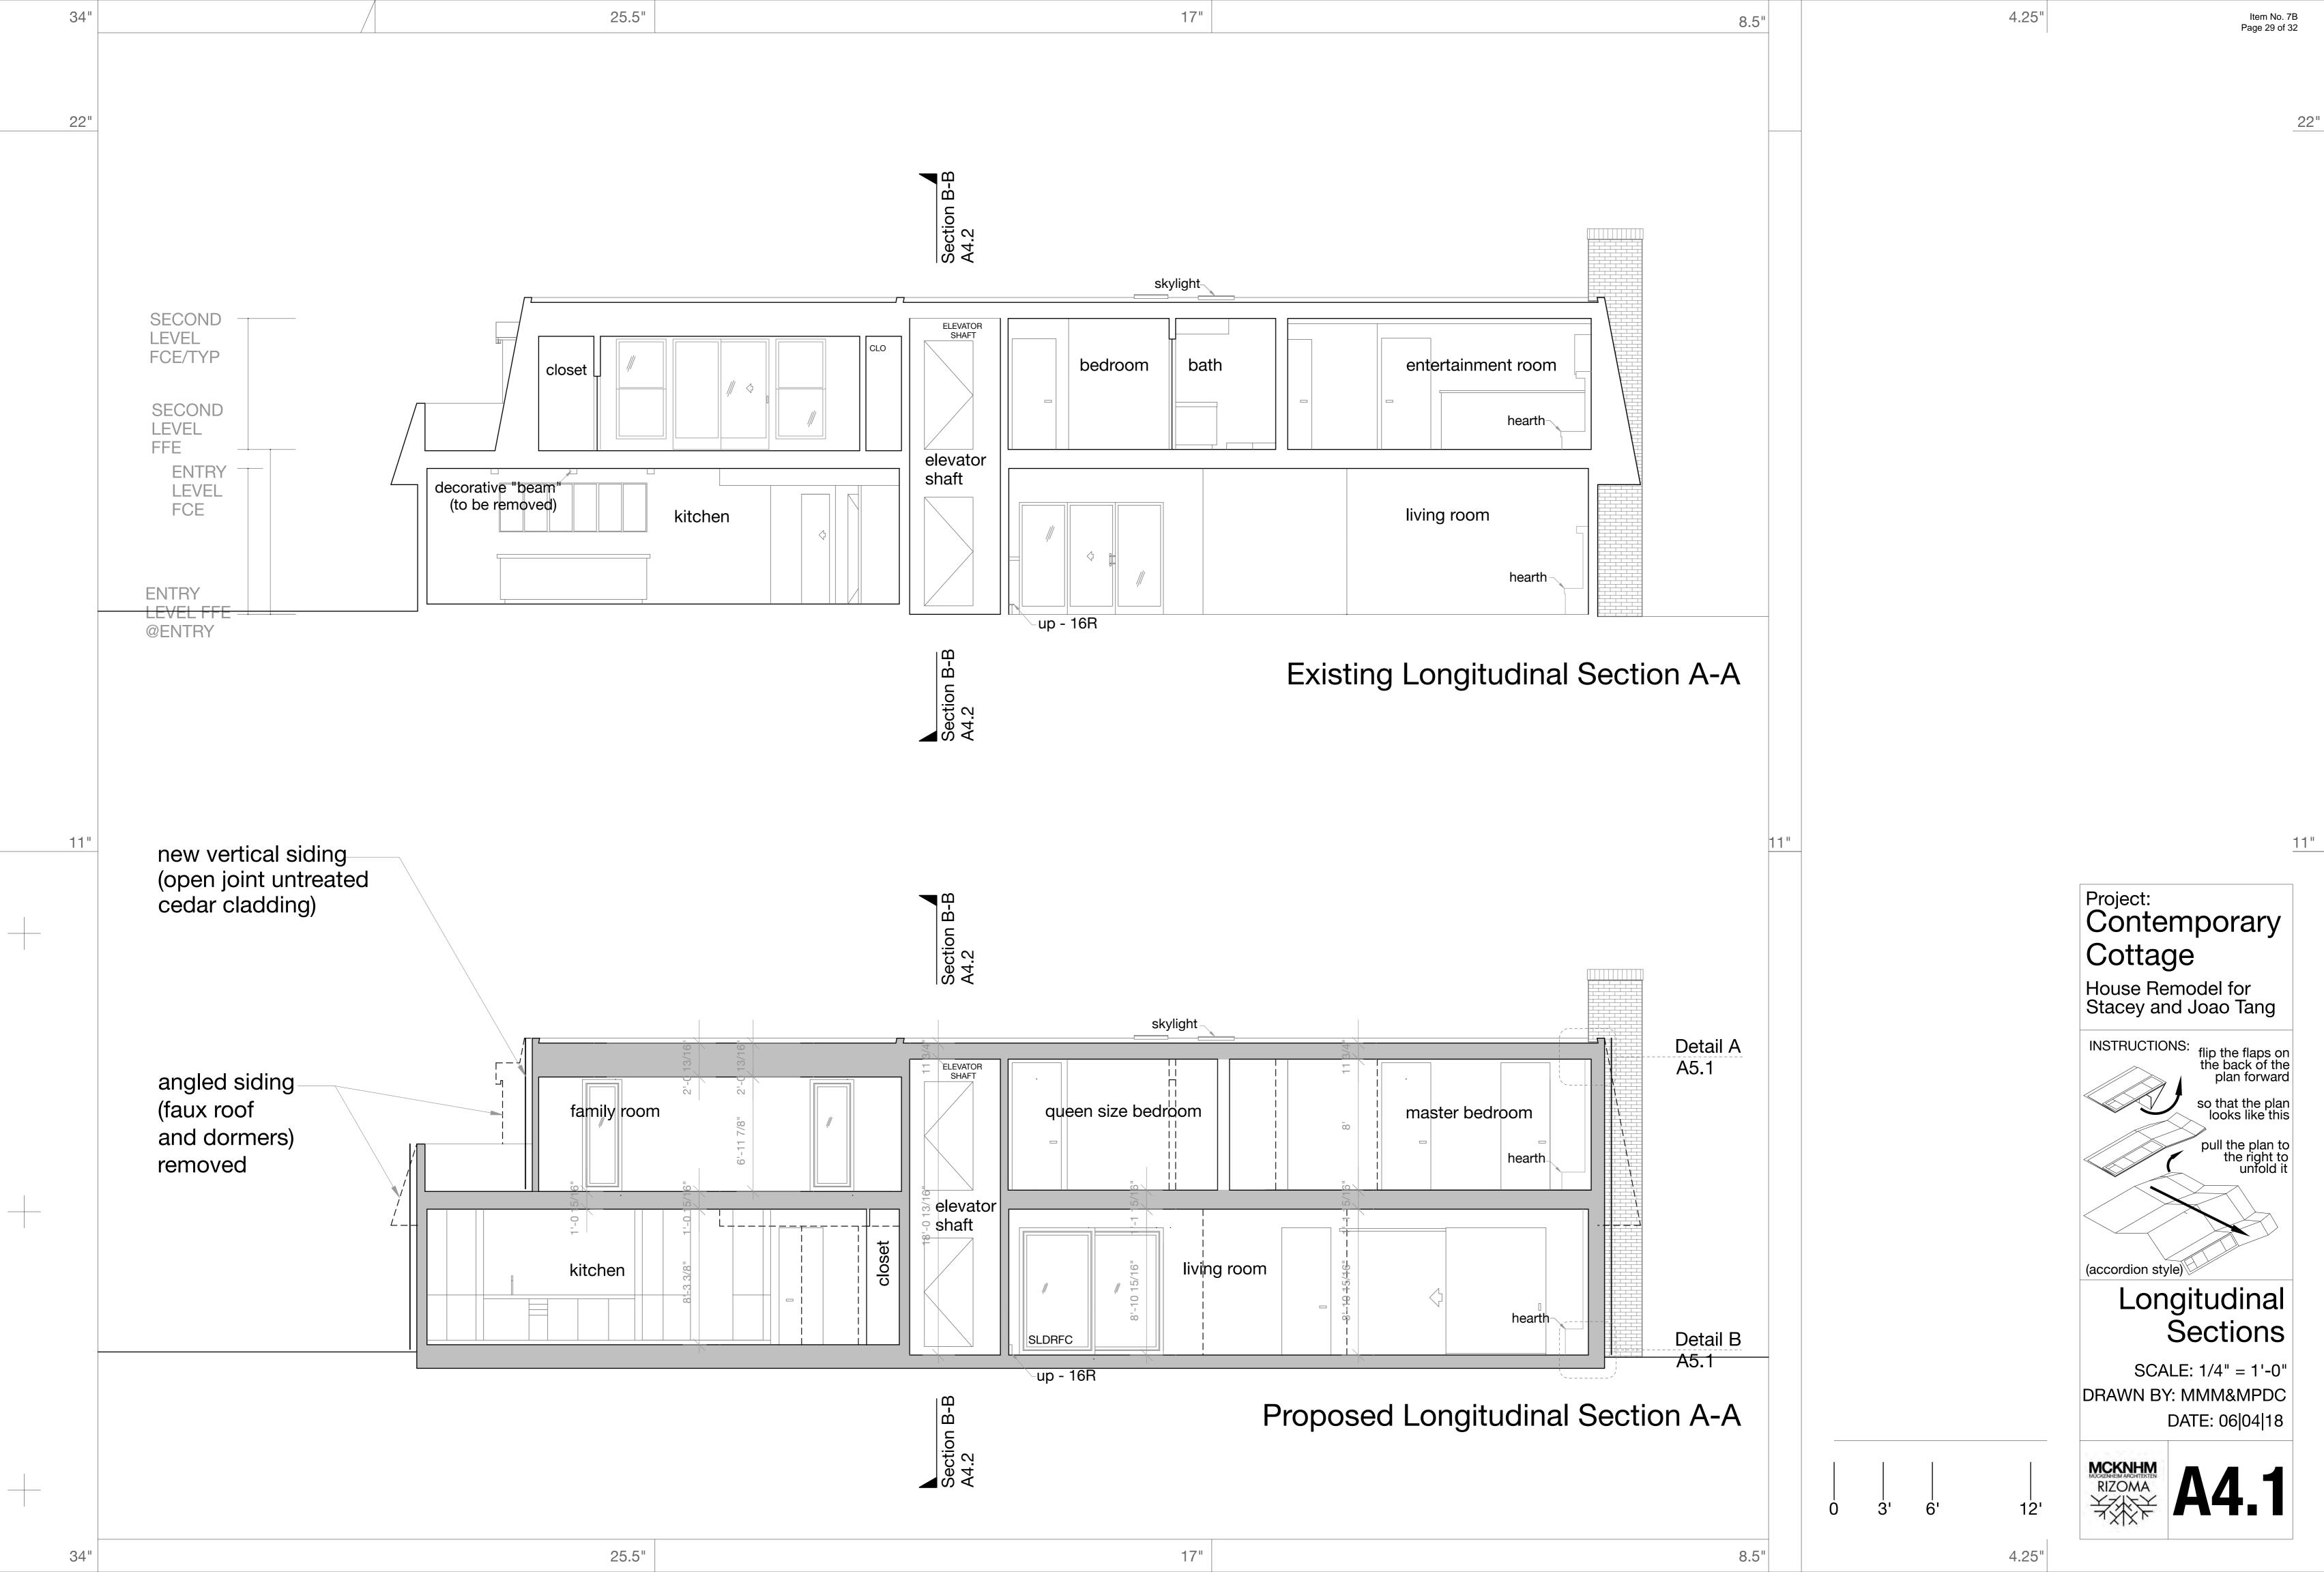


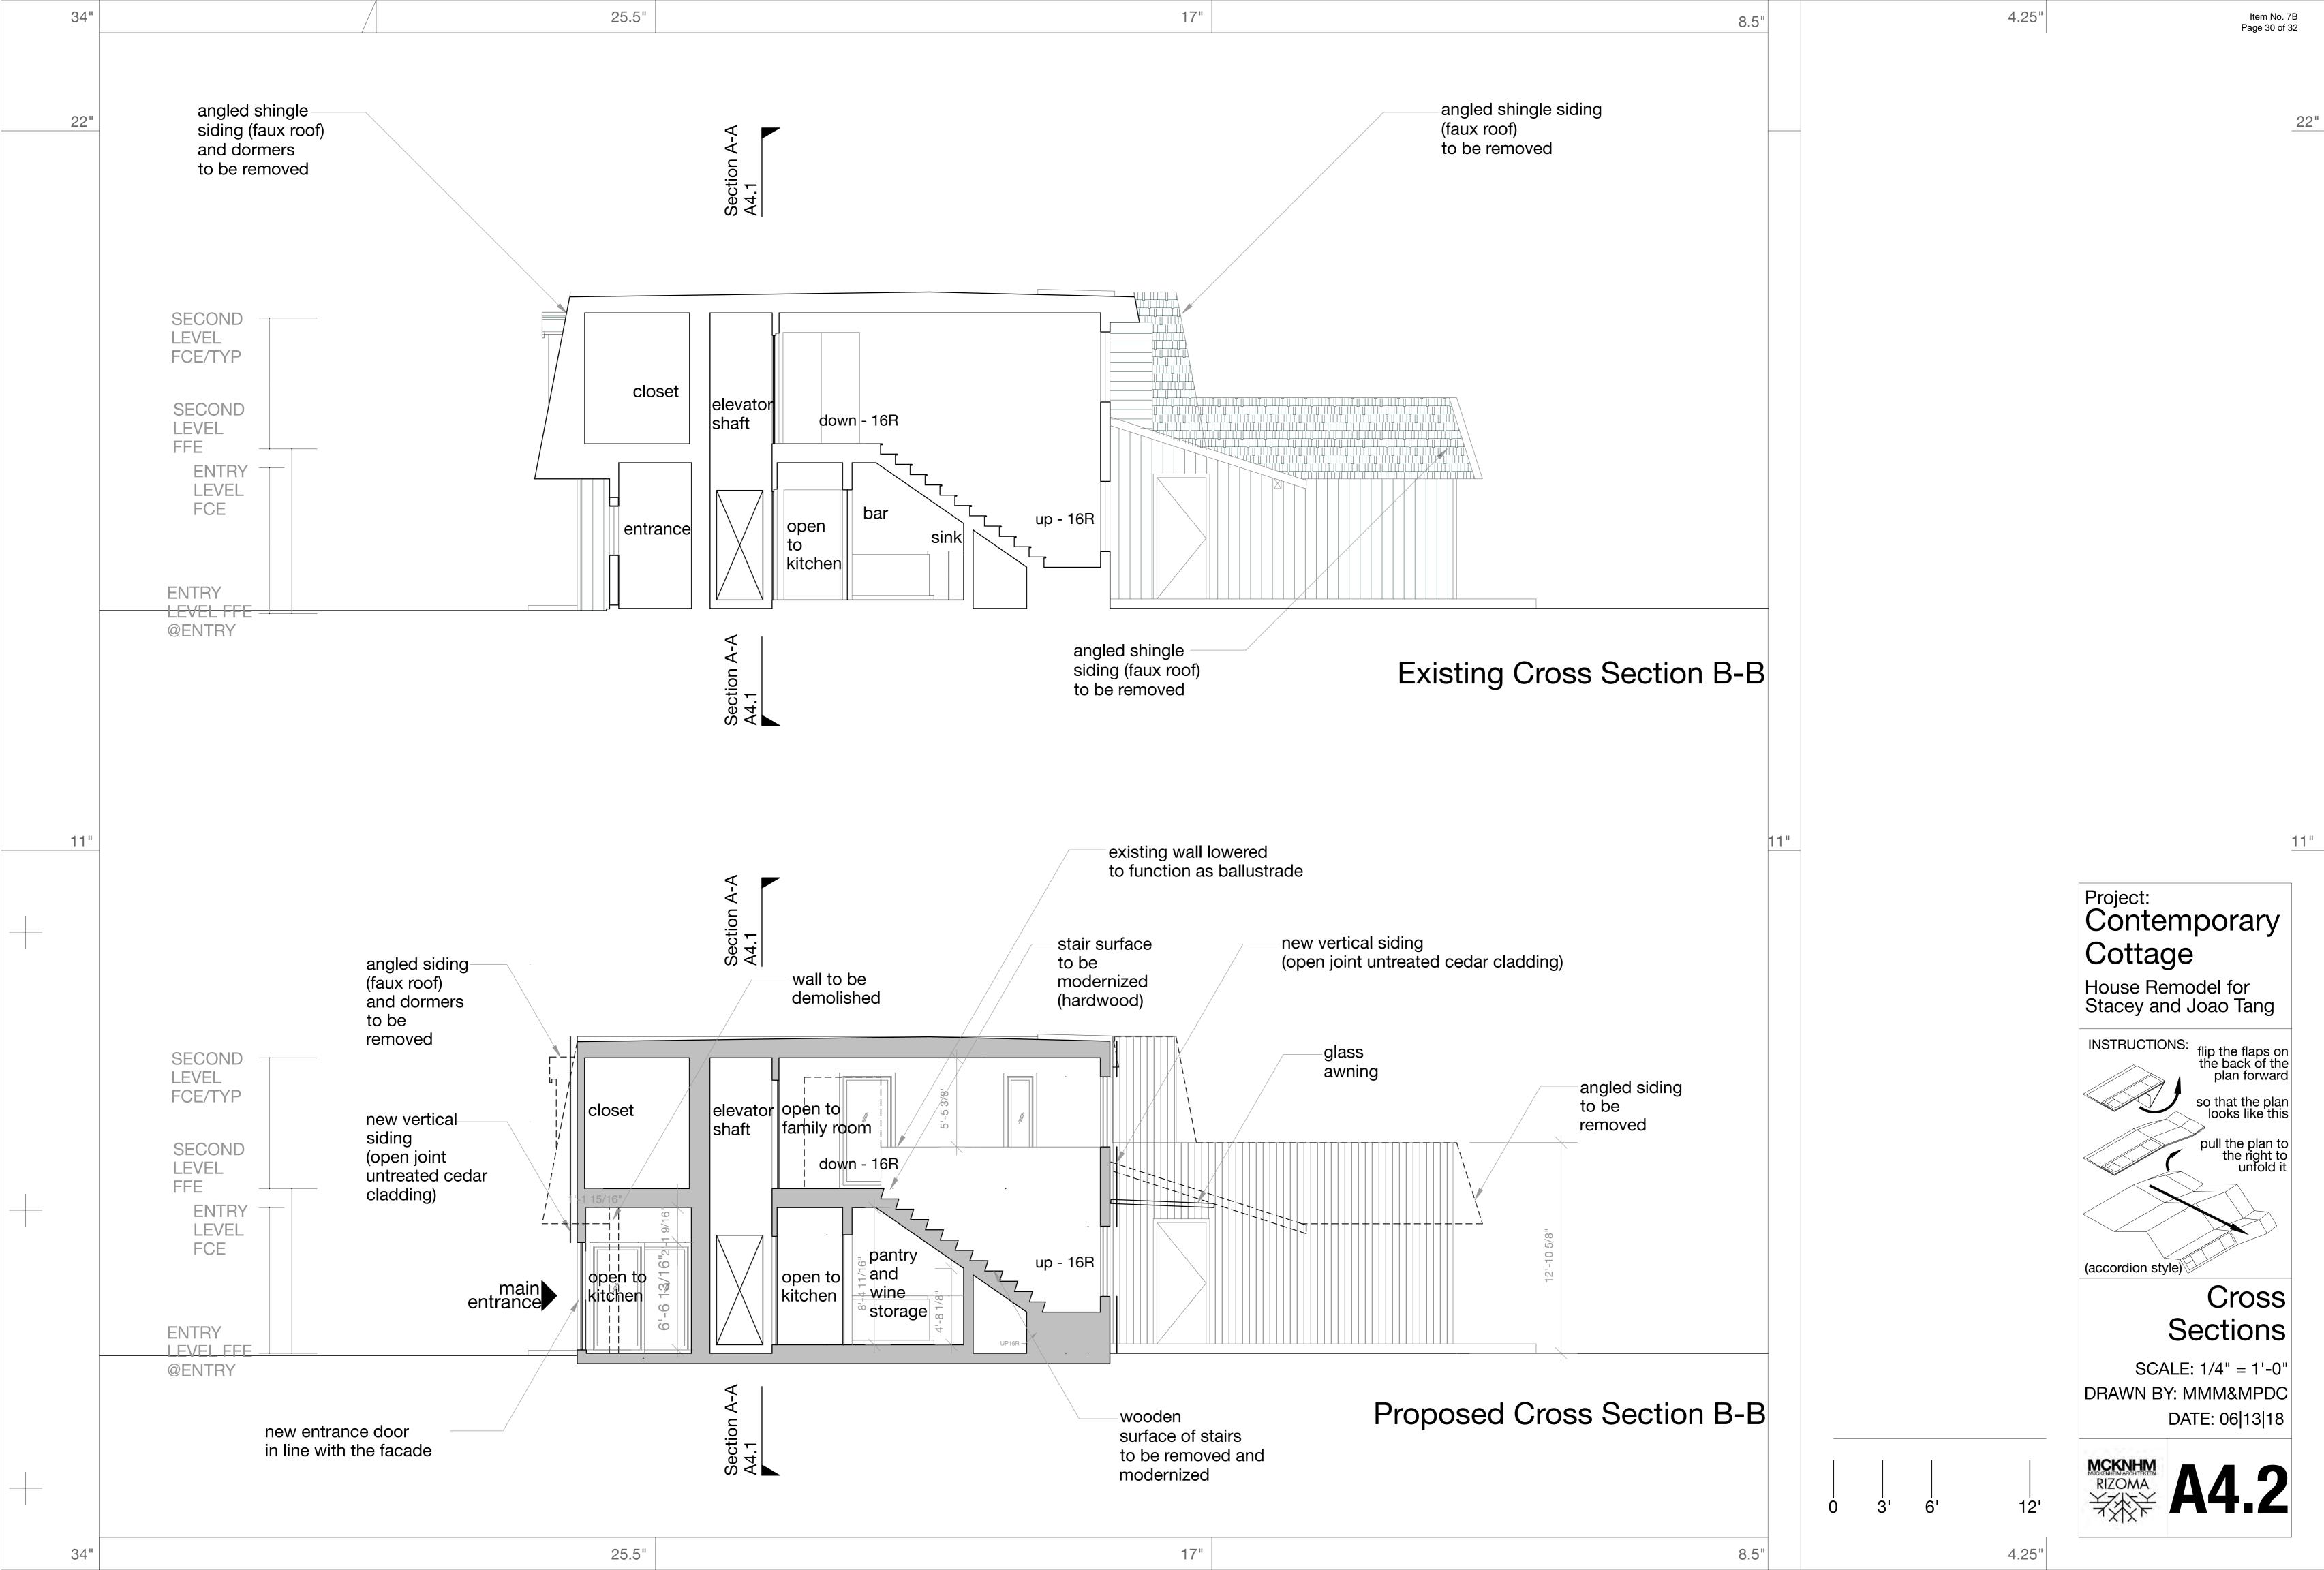

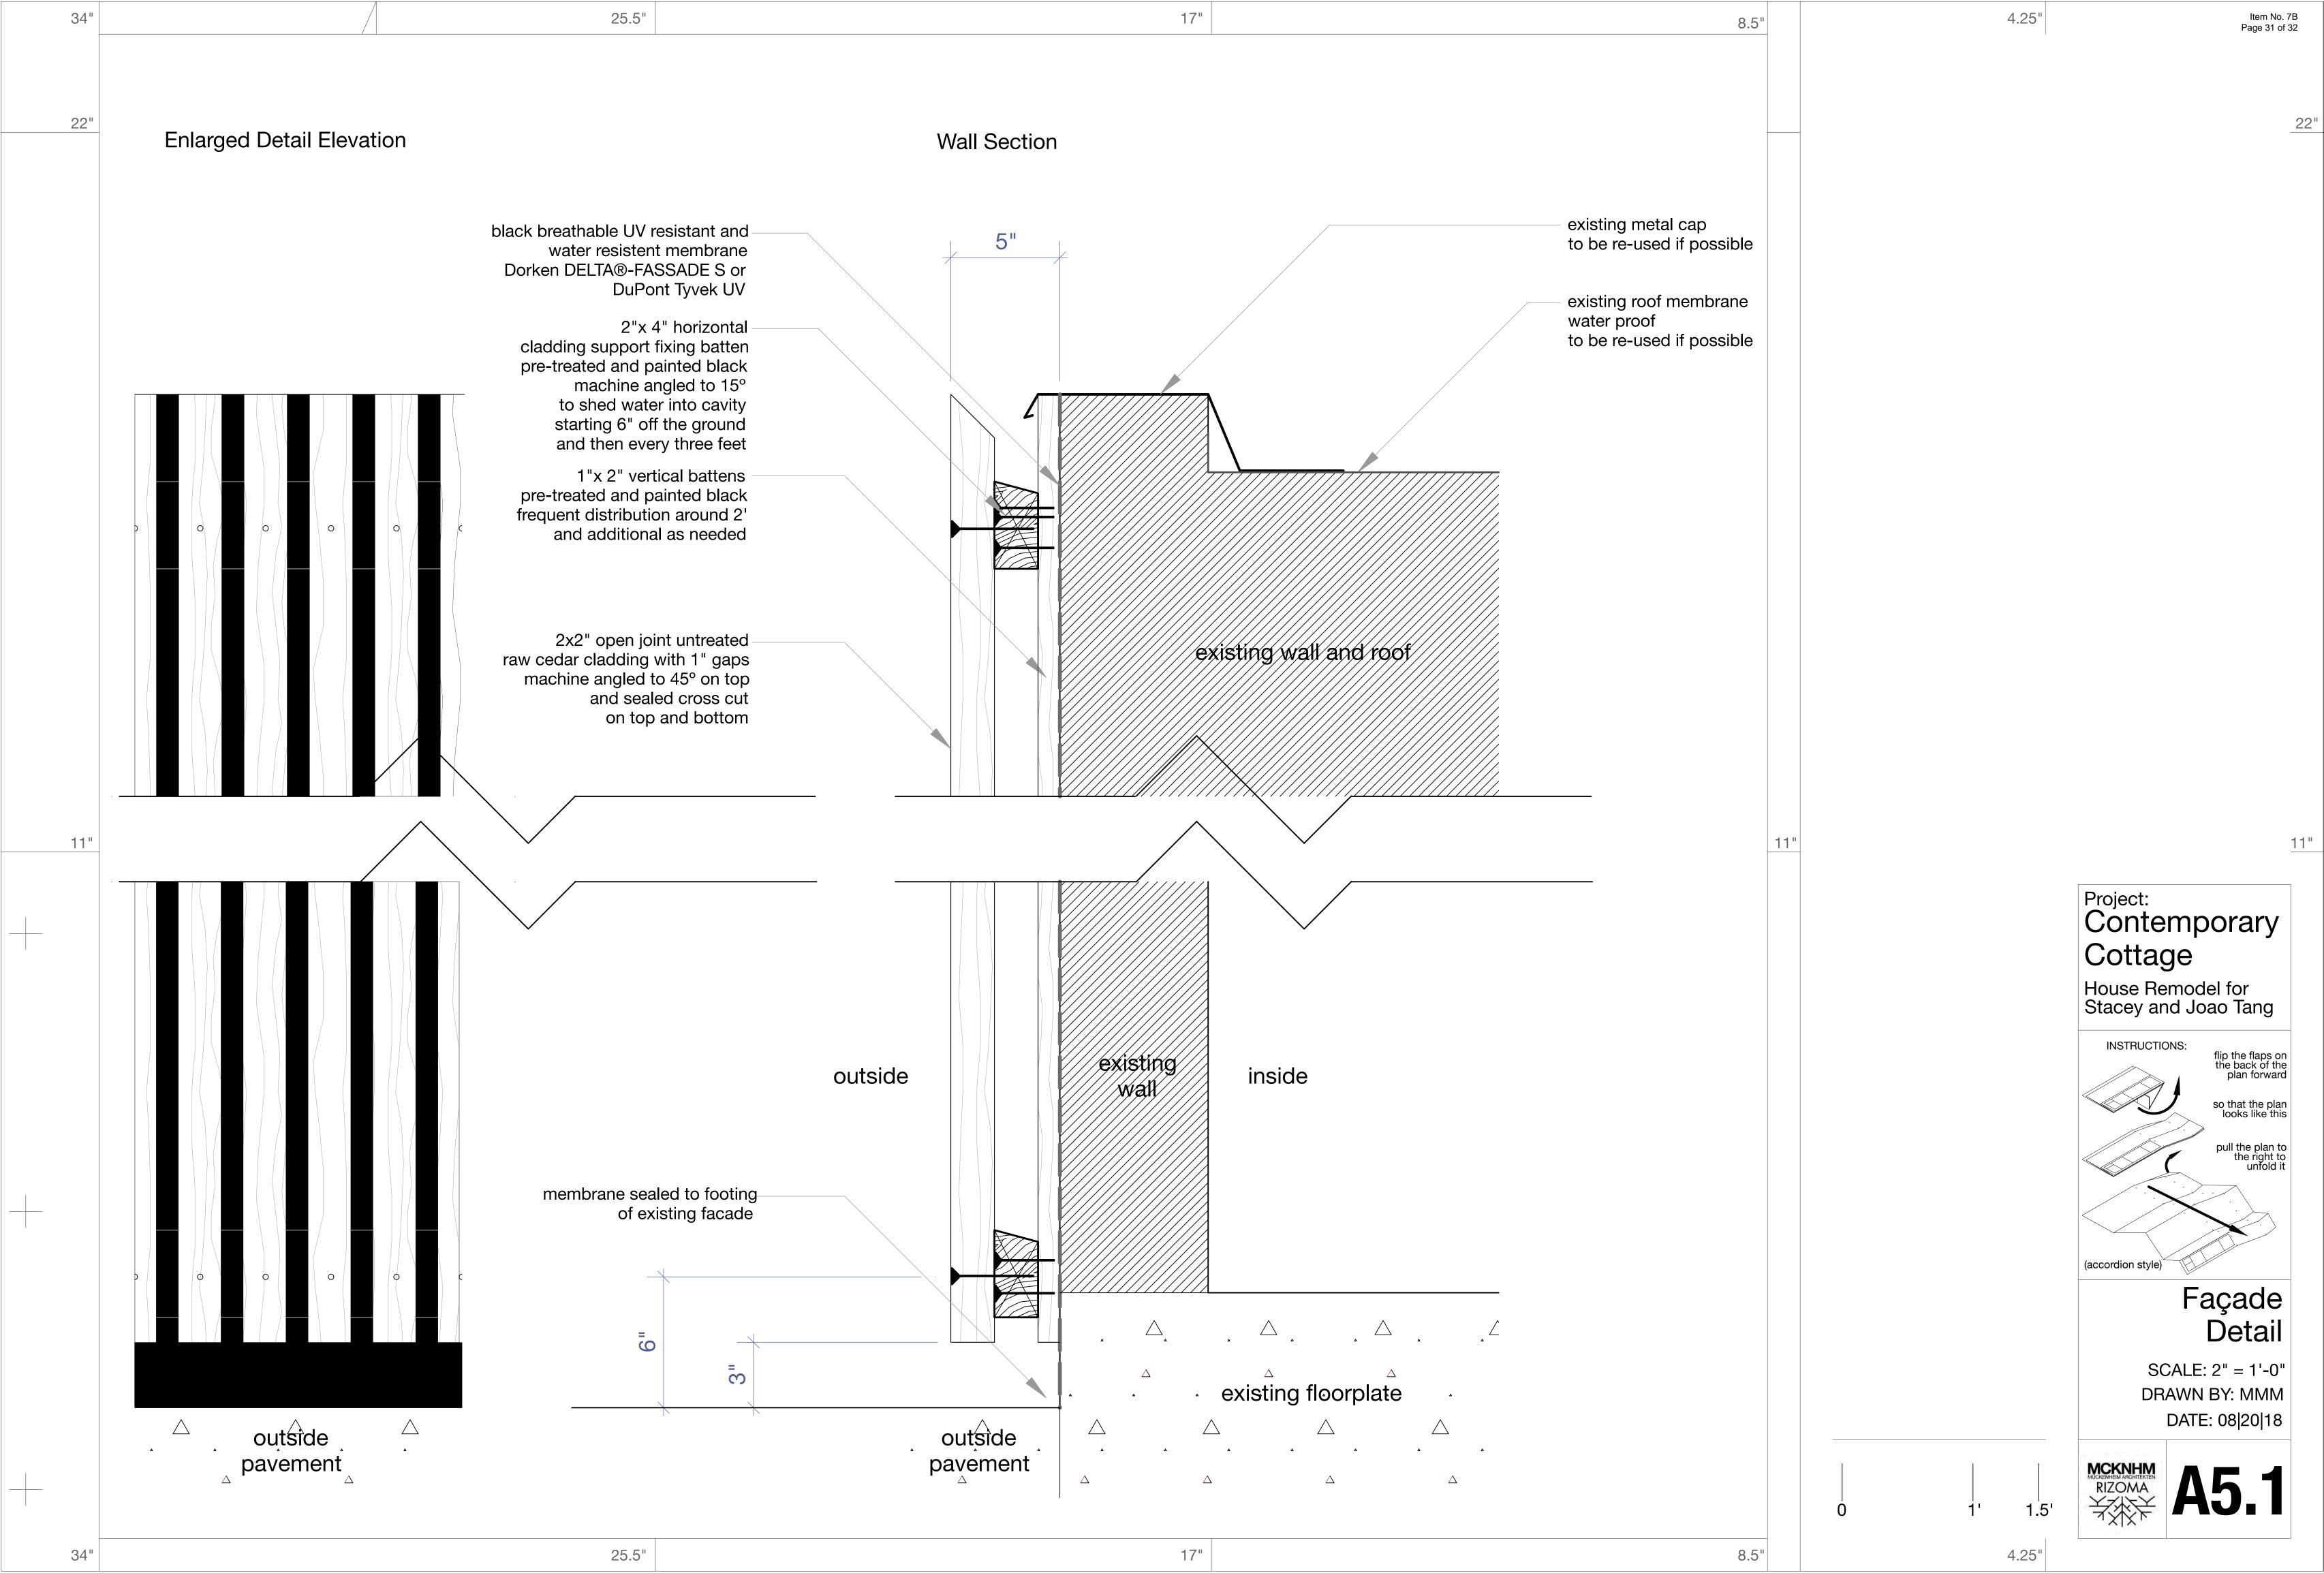



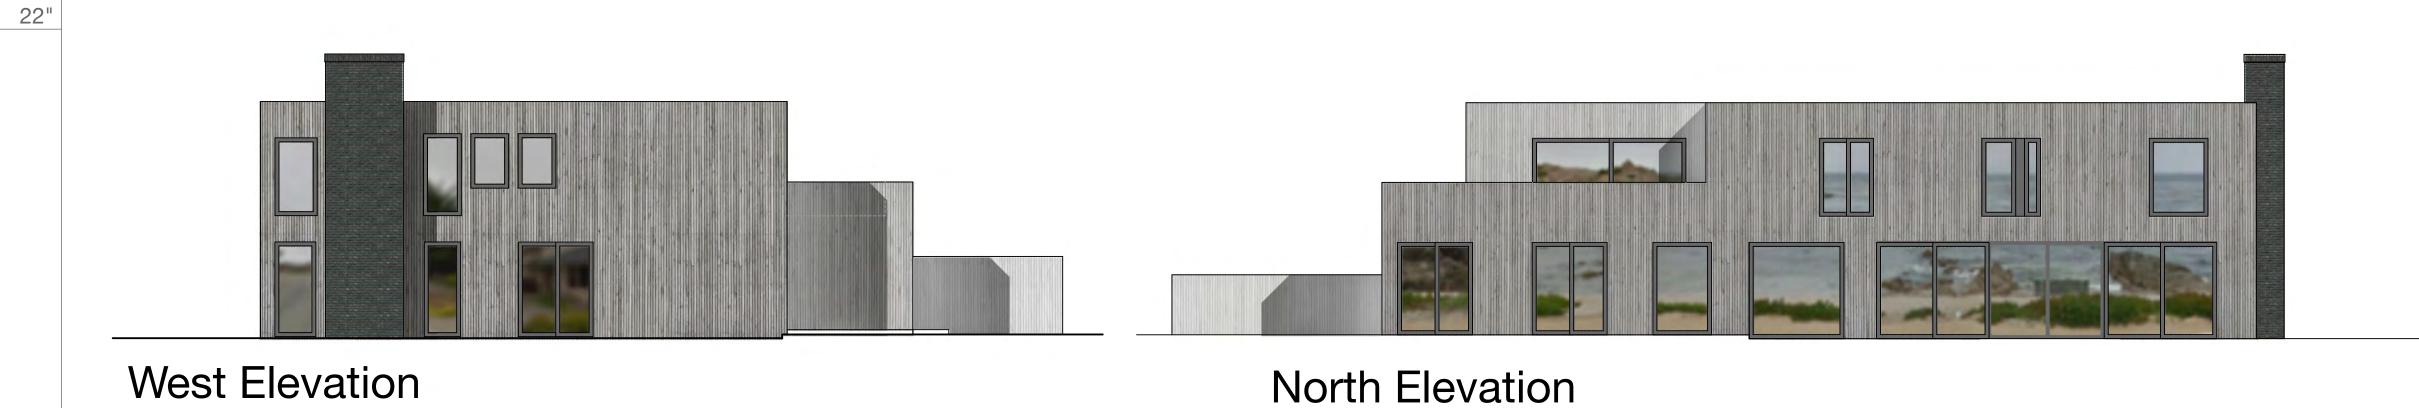

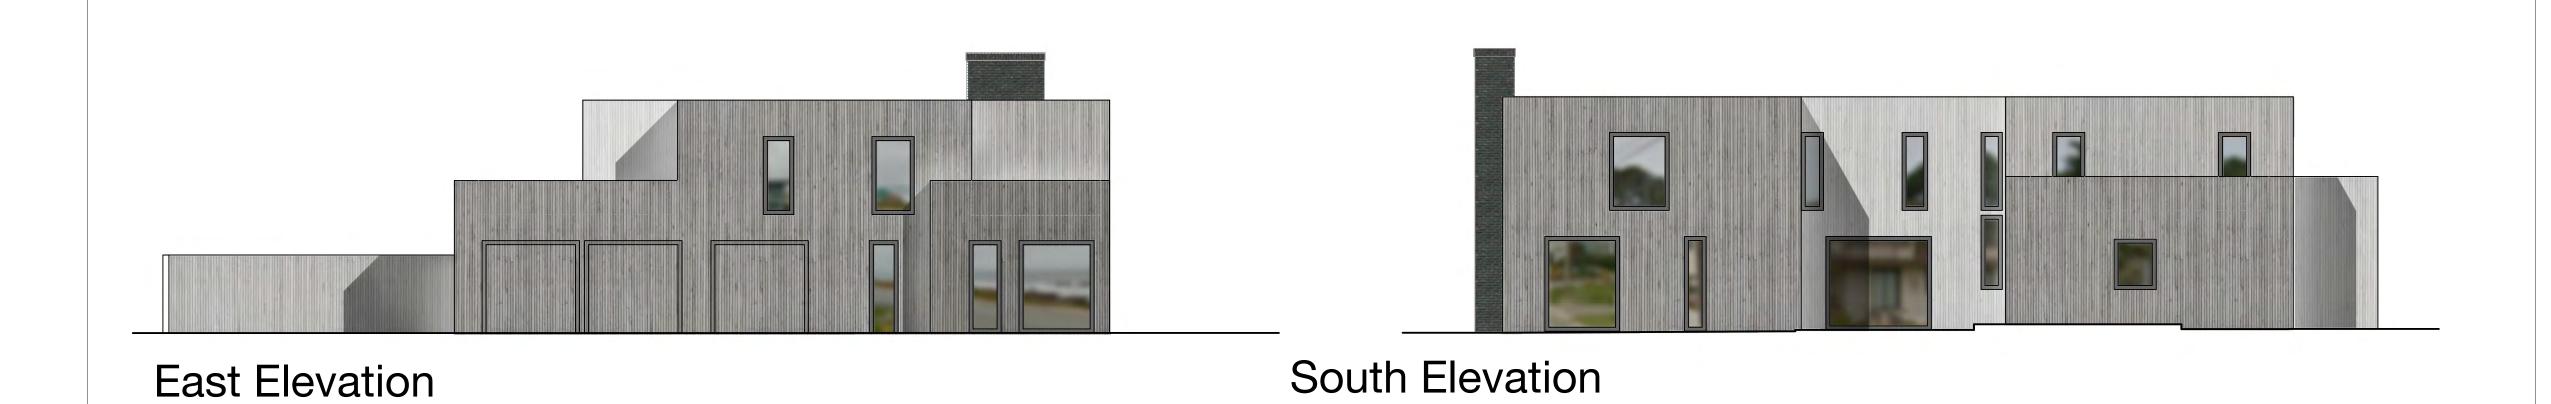




Examples of the newly projected untreated open Cedar Cladding

The wood will attain a beautiful natural grey over time, this weathered look is in line with many contemporary or modern buildings along the Northern California Coast since the 1960s (Sea Ranch)

Door and Window Frames

Modern Fleetwood or Western Window Systems Clear Anodize (Aluminum) or Dark Bronze Anodize Frames (the elevations above show the Bronze version which we probably prefer)

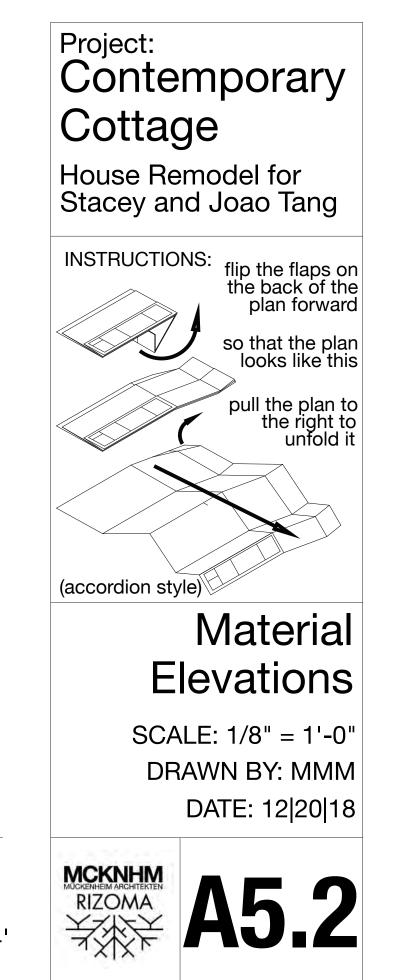

25.5" 17" 8.5"